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C102 - GRADING PLAN

C103 - STORMWATER RUNOFF PLAN

C104 - UTILITY PLAN

C105 - DEMOLITION PLAN

C106 - EROSION CONTROL PLAN

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C108 - WATER SERVICE DETAILS

C109 - EROSION CONTROL DETAILS

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A100 - EAST ELEVATION

A101 - WEST ELEVATION

A102 - SOUTH ELEVATION

A103 - NORTH ELEVATION

A104 - FLOOR PLAN

2. STRUCTURAL PLAN SHEETS

S100 -FOUNDATION PLAN


S101 - MAIN FLOOR PLAN

S102 - ROOF FRAMING PLAN

BEACON CITY HALL PRELIMINARY DESIGN

TO THE CITY OF BEACON, IA



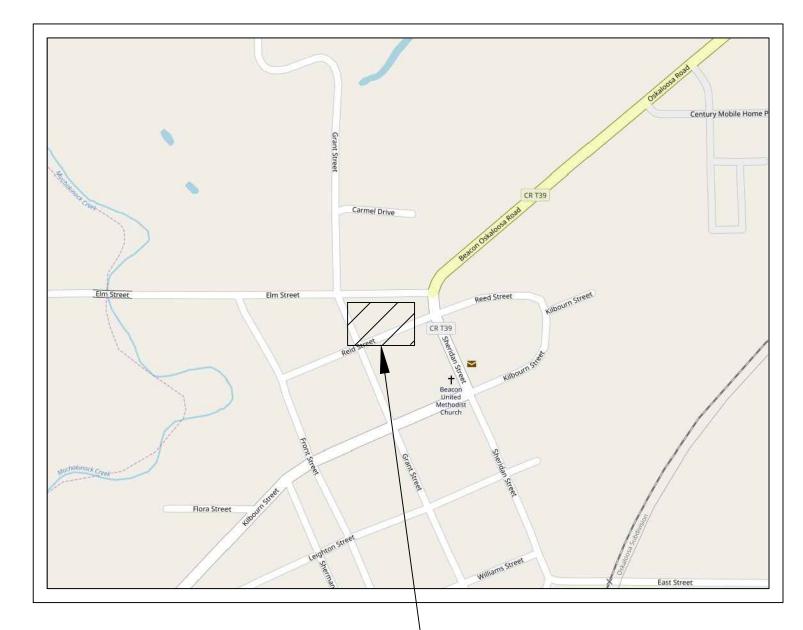

APPROXIMATE SITE LOCATION

EDUCATIONAL - NOT FOR CONSTRUCTION

SHEET NAME

BEACON

COVER SHEET

SHEET NO.

G100

General Notes:

future for a final construction drawing set.

B. Governing building code IBC 2012

C. Project documentation and design was based off as much detail of initial research as possible. However the existing A. The intent of these plans are to present the project requirements for the design of a city hall for the town of lowa. These drawing sets are prelimenary construction conditions on site may vary from initial obtained information. drawings. Further minor details will need to be added in the

| - |
|--|
| 2. Dead load10psf |
| 1. Live Load20psf |
| a. Upper Roof |
| 3. Gravity Loads |
| e. Flat roof snow load21 psf |
| d. Ground snow load25 psf |
| c. exposure factor1.0 |
| b. Thermal factor1.0 |
| a. Importance factor1.0 |
| 2. Snow Loading |
| d. Exposure CategoryC |
| c. Importance factor1.0 |
| b. Design wind speed107 mph |
| a. Risk CategoryII |
| 1. Wind Loading |
| D. Design loads: |
| Conditions on site may vary nom initial obtained information |

| e. Flat roof snow load21 psf | d. Ground snow load25 psf |
|------------------------------|------------------------------|
| | e. Flat roof snow load21 psf |

| | 2. Dead load6psf | 1. Live Load20ps | b. Overhang Roof | 2. Dead load10ր | 1. Live Load20psf | b. Lower Roof |
|---|------------------|------------------|------------------|-----------------|-------------------|---------------|
| • | 6psf | 20psf | | 10psf | 20psf | |

b. total Load.......P/240 Allowable bearing soil pressure from IBC......1500psf Deflection a. Service load.. L/360L/240

Concrete:

Wood:

All sawn lumber wood construction material was designed for Douglas fir Larch NO. 1 or better with design values:

1. Fb: 1000psi
2. Fv: 180psi

. Fc: 1500psi . E: 1700000psi

Ft: 675psi

| C. All steel reinforcement will be Gr 60 with no epoxy D. All splice length will follow ACI 318 | D. All concrete placed against earth must allow 3" minimum clear cover for steel reinforcement. | C. minimum concrete for interior floor slab at 28 days is 4000psi without air entrainment. | B. Minimum concrete compressive strength for foundation at 28 days is 3000psi with air entrainment | A. Concrete requirements are based off of ACI 318 and ACI 301 |
|--|---|--|--|---|
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General Notes

Beacon Iowa City Hall

409 Reid St beacon IA




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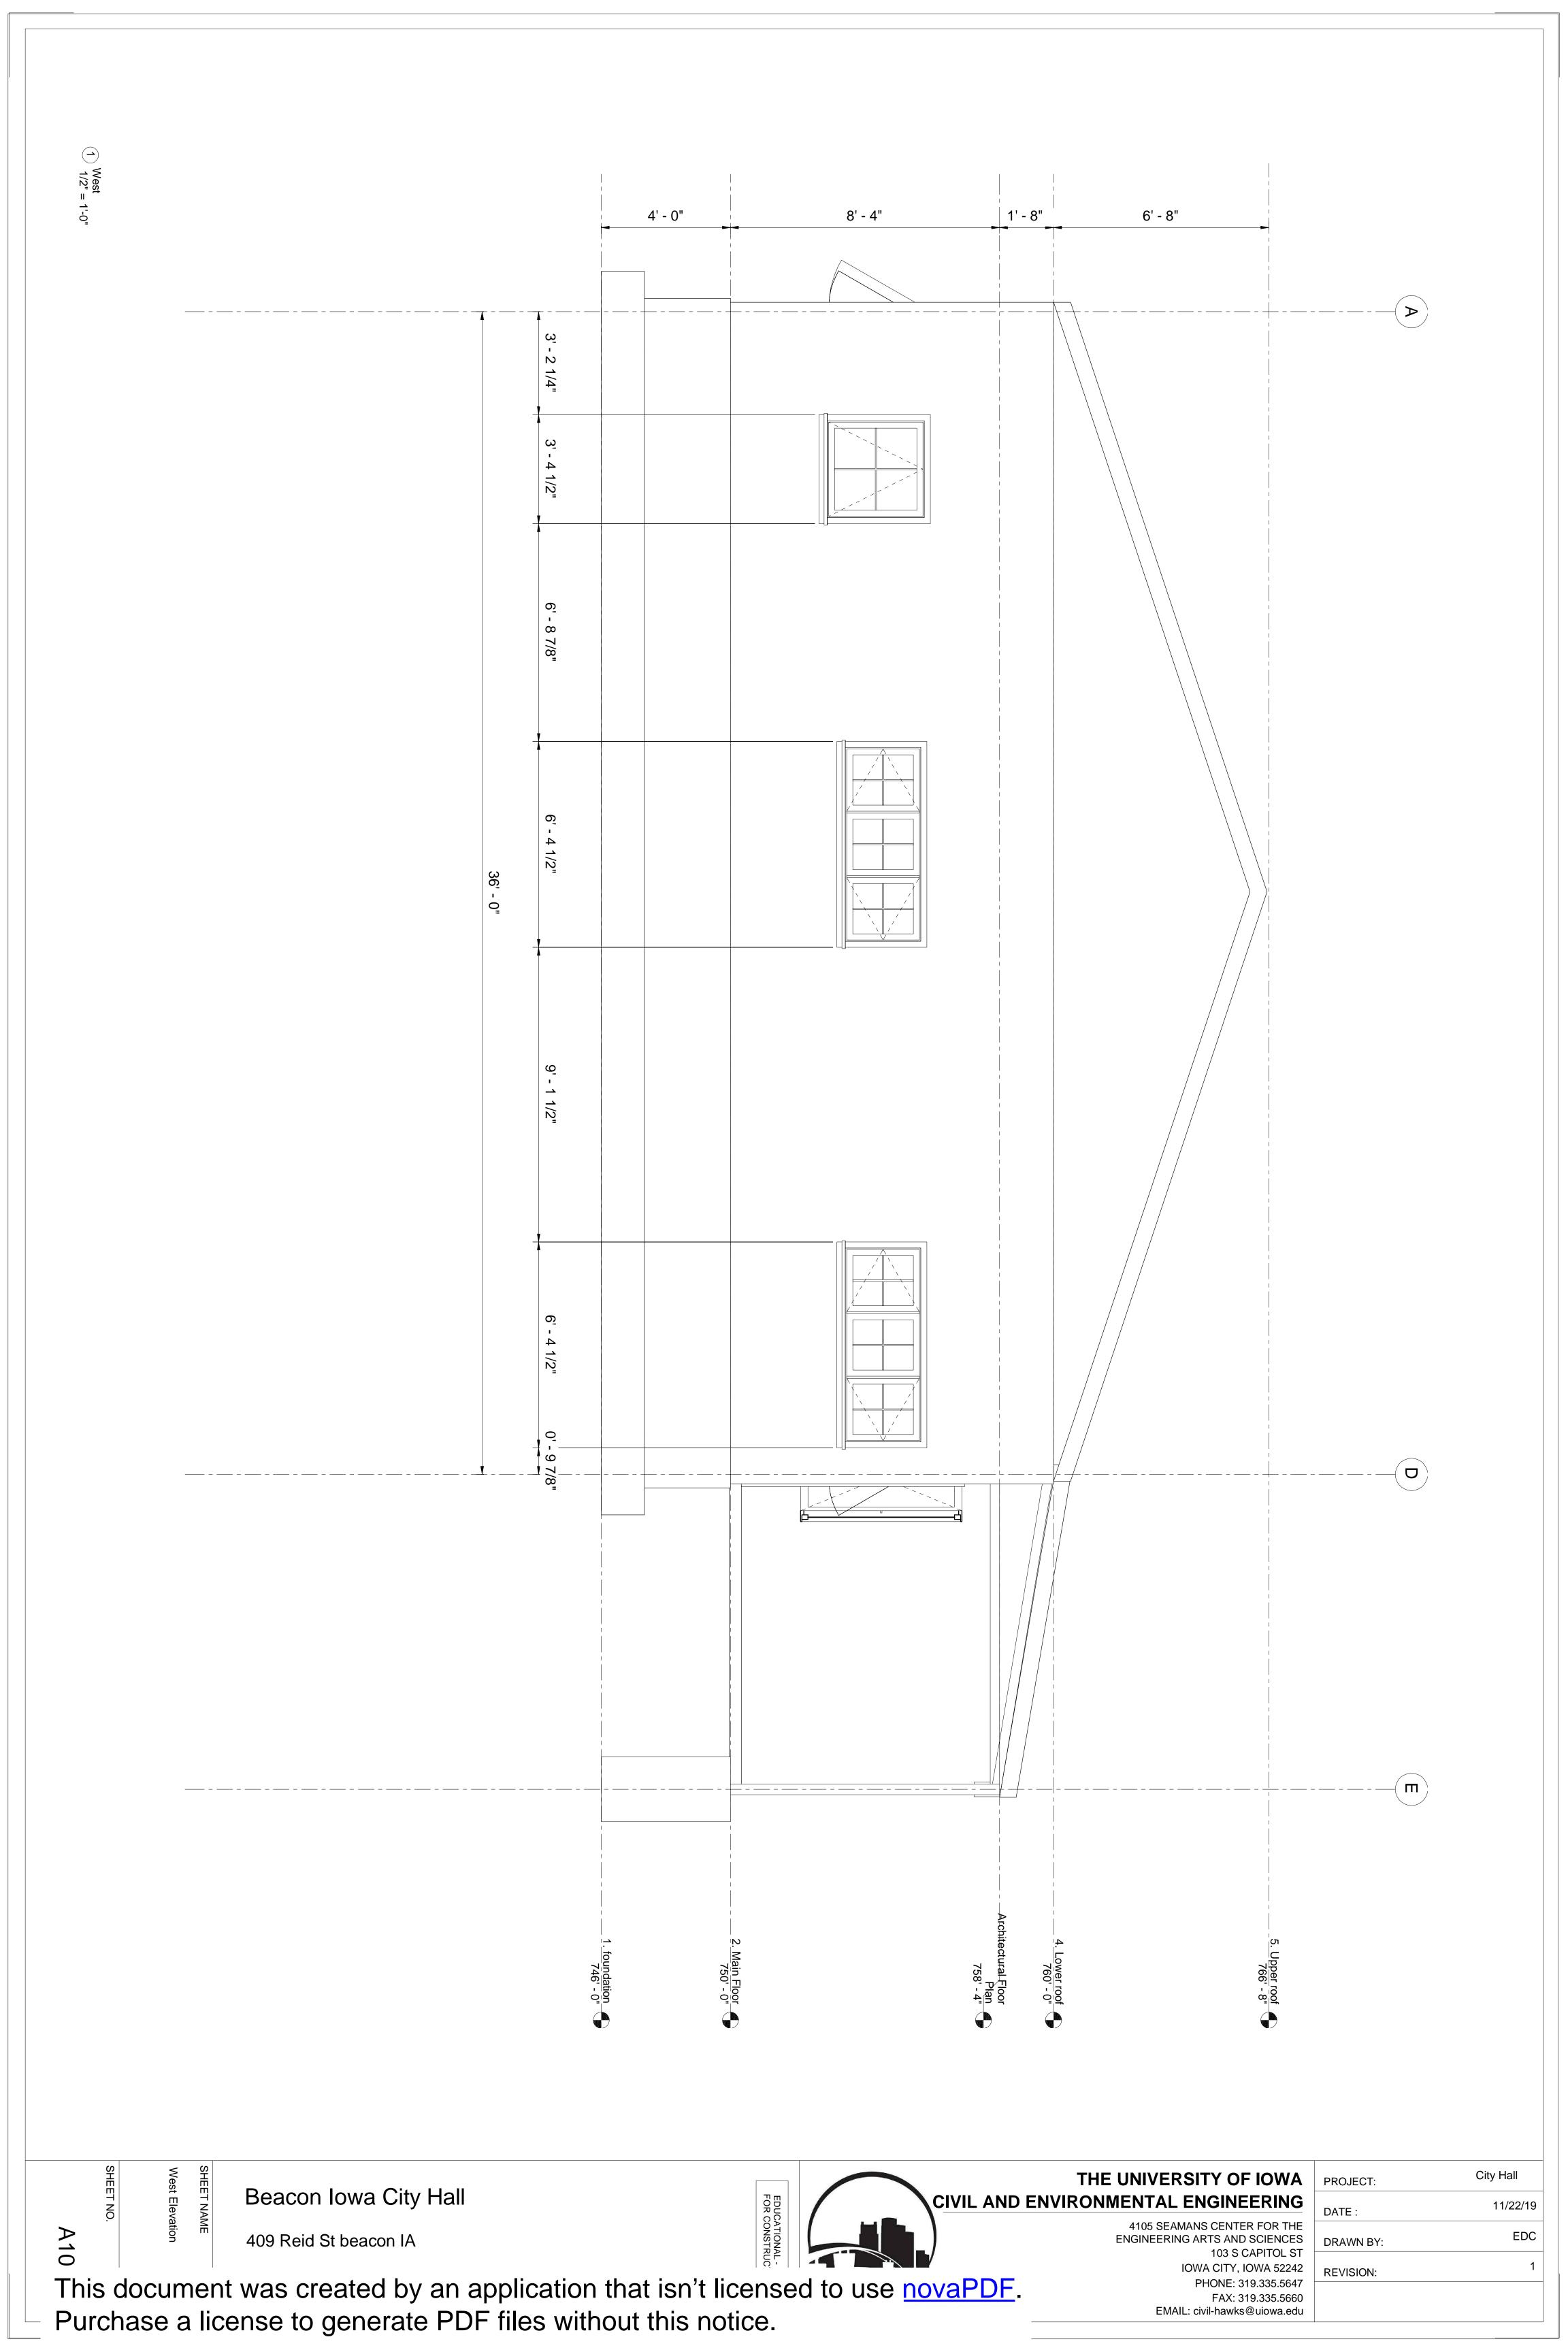
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|-----------------|----------|----------|------|
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| ENGINEERING A | ARTS ANI | D SCIEN | ICES |
| | 103 S | CAPITO | L ST |
| IO ¹ | WA CITY, | IOWA 5 | 2242 |
| | PHONE: 3 | 319.335. | 5647 |
| | FAX: 3 | 319.335. | 5660 |


EMAIL: civil-hawks@uiowa.edu

| 4 | PROJECT: | City Hall |
|----------------|-----------|-----------|
| 3 | DATE : | 11/22/19 |
| IE S | DRAWN BY: | EDC |
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SHEET NAME

South elevation

SHEET NO.

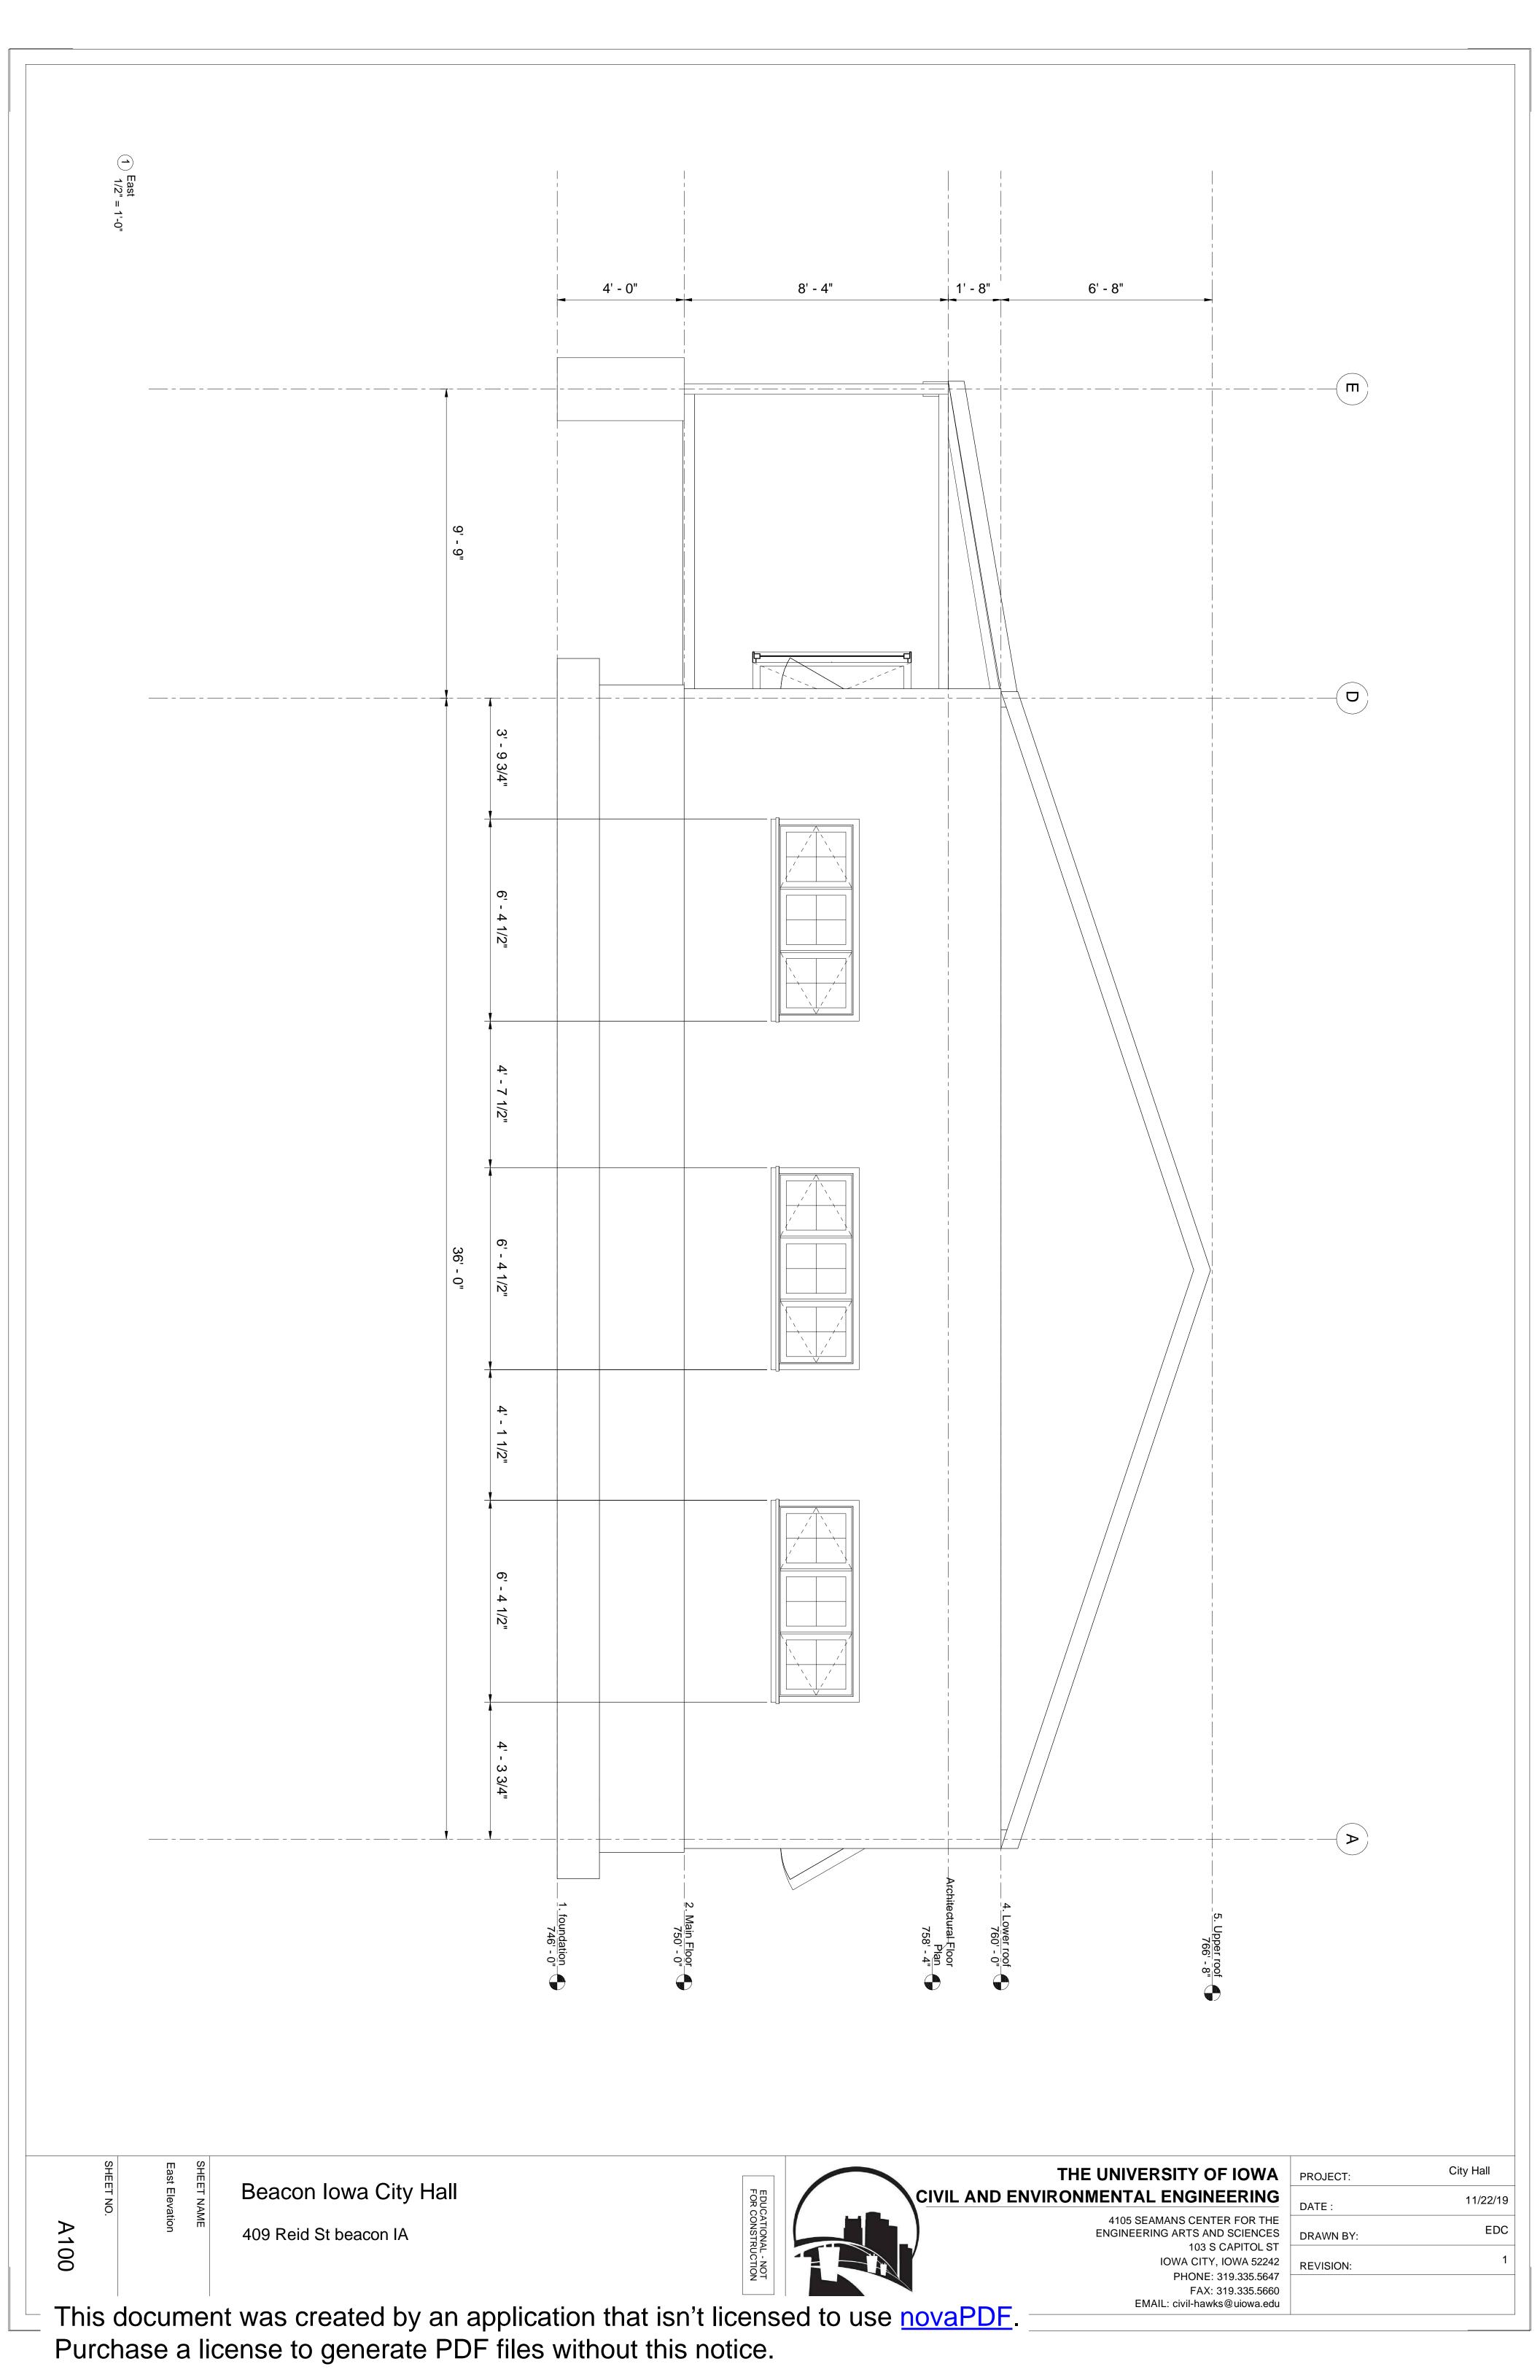Beacon Iowa City Hall
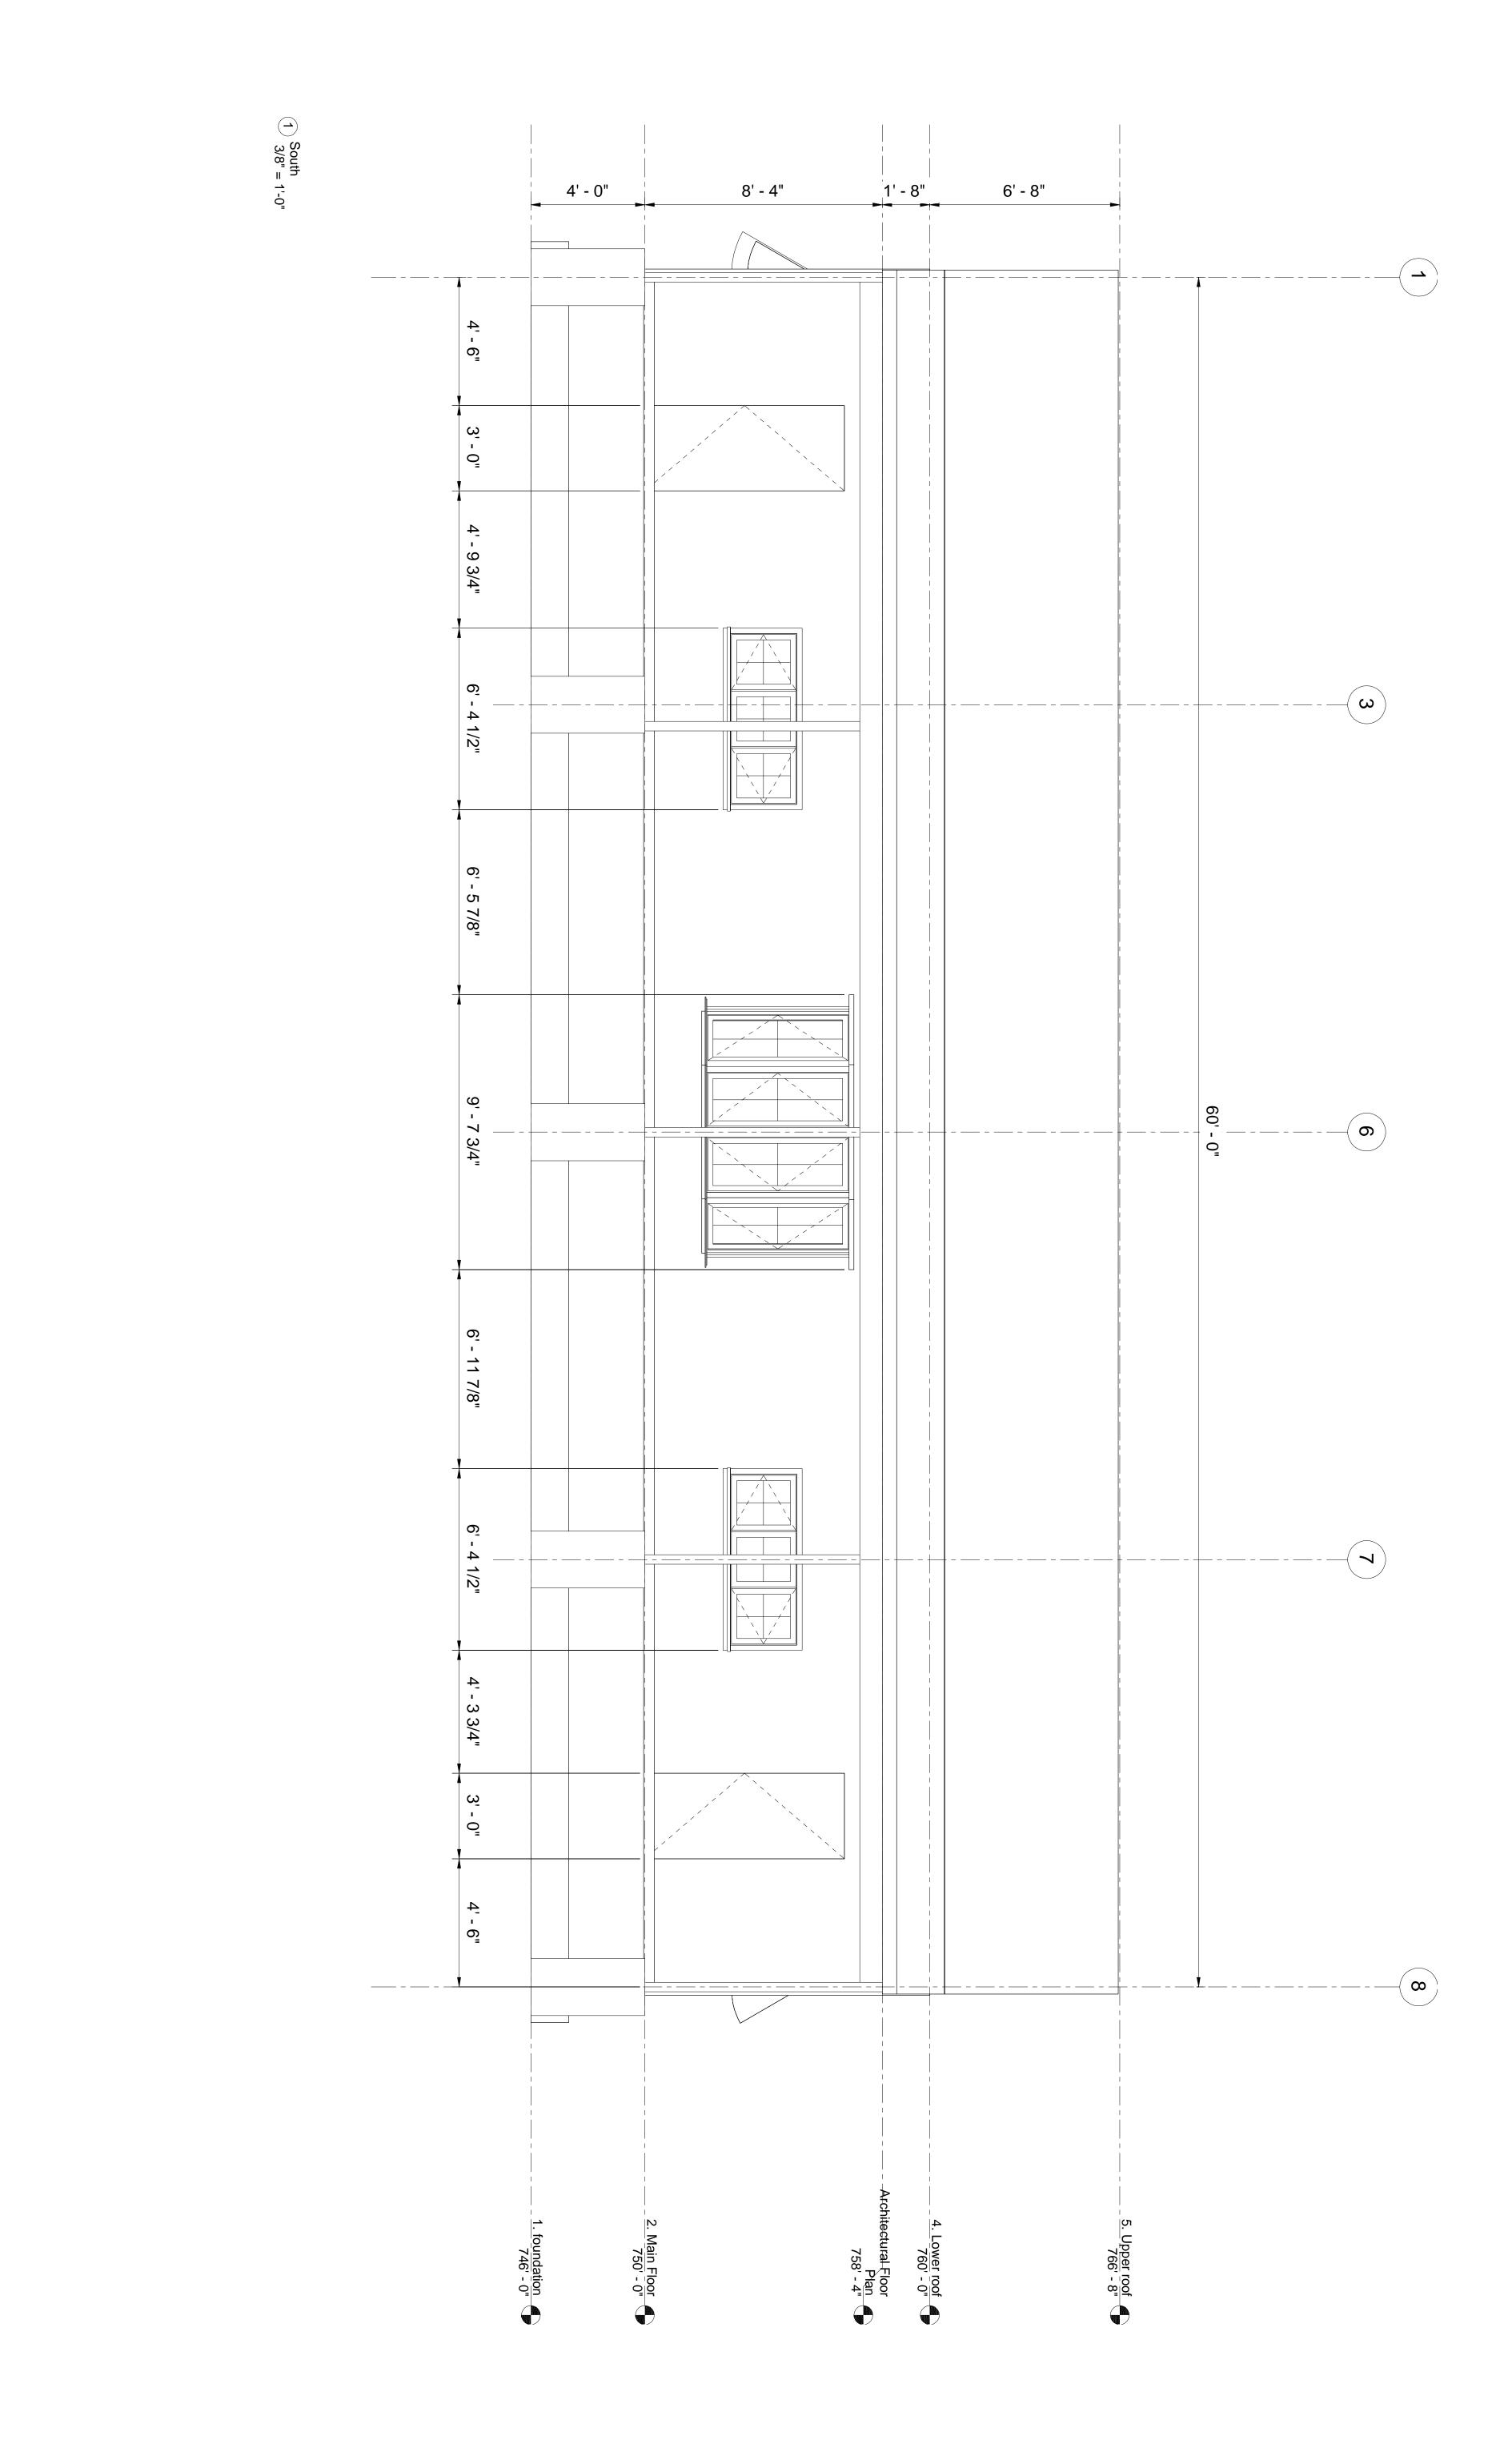
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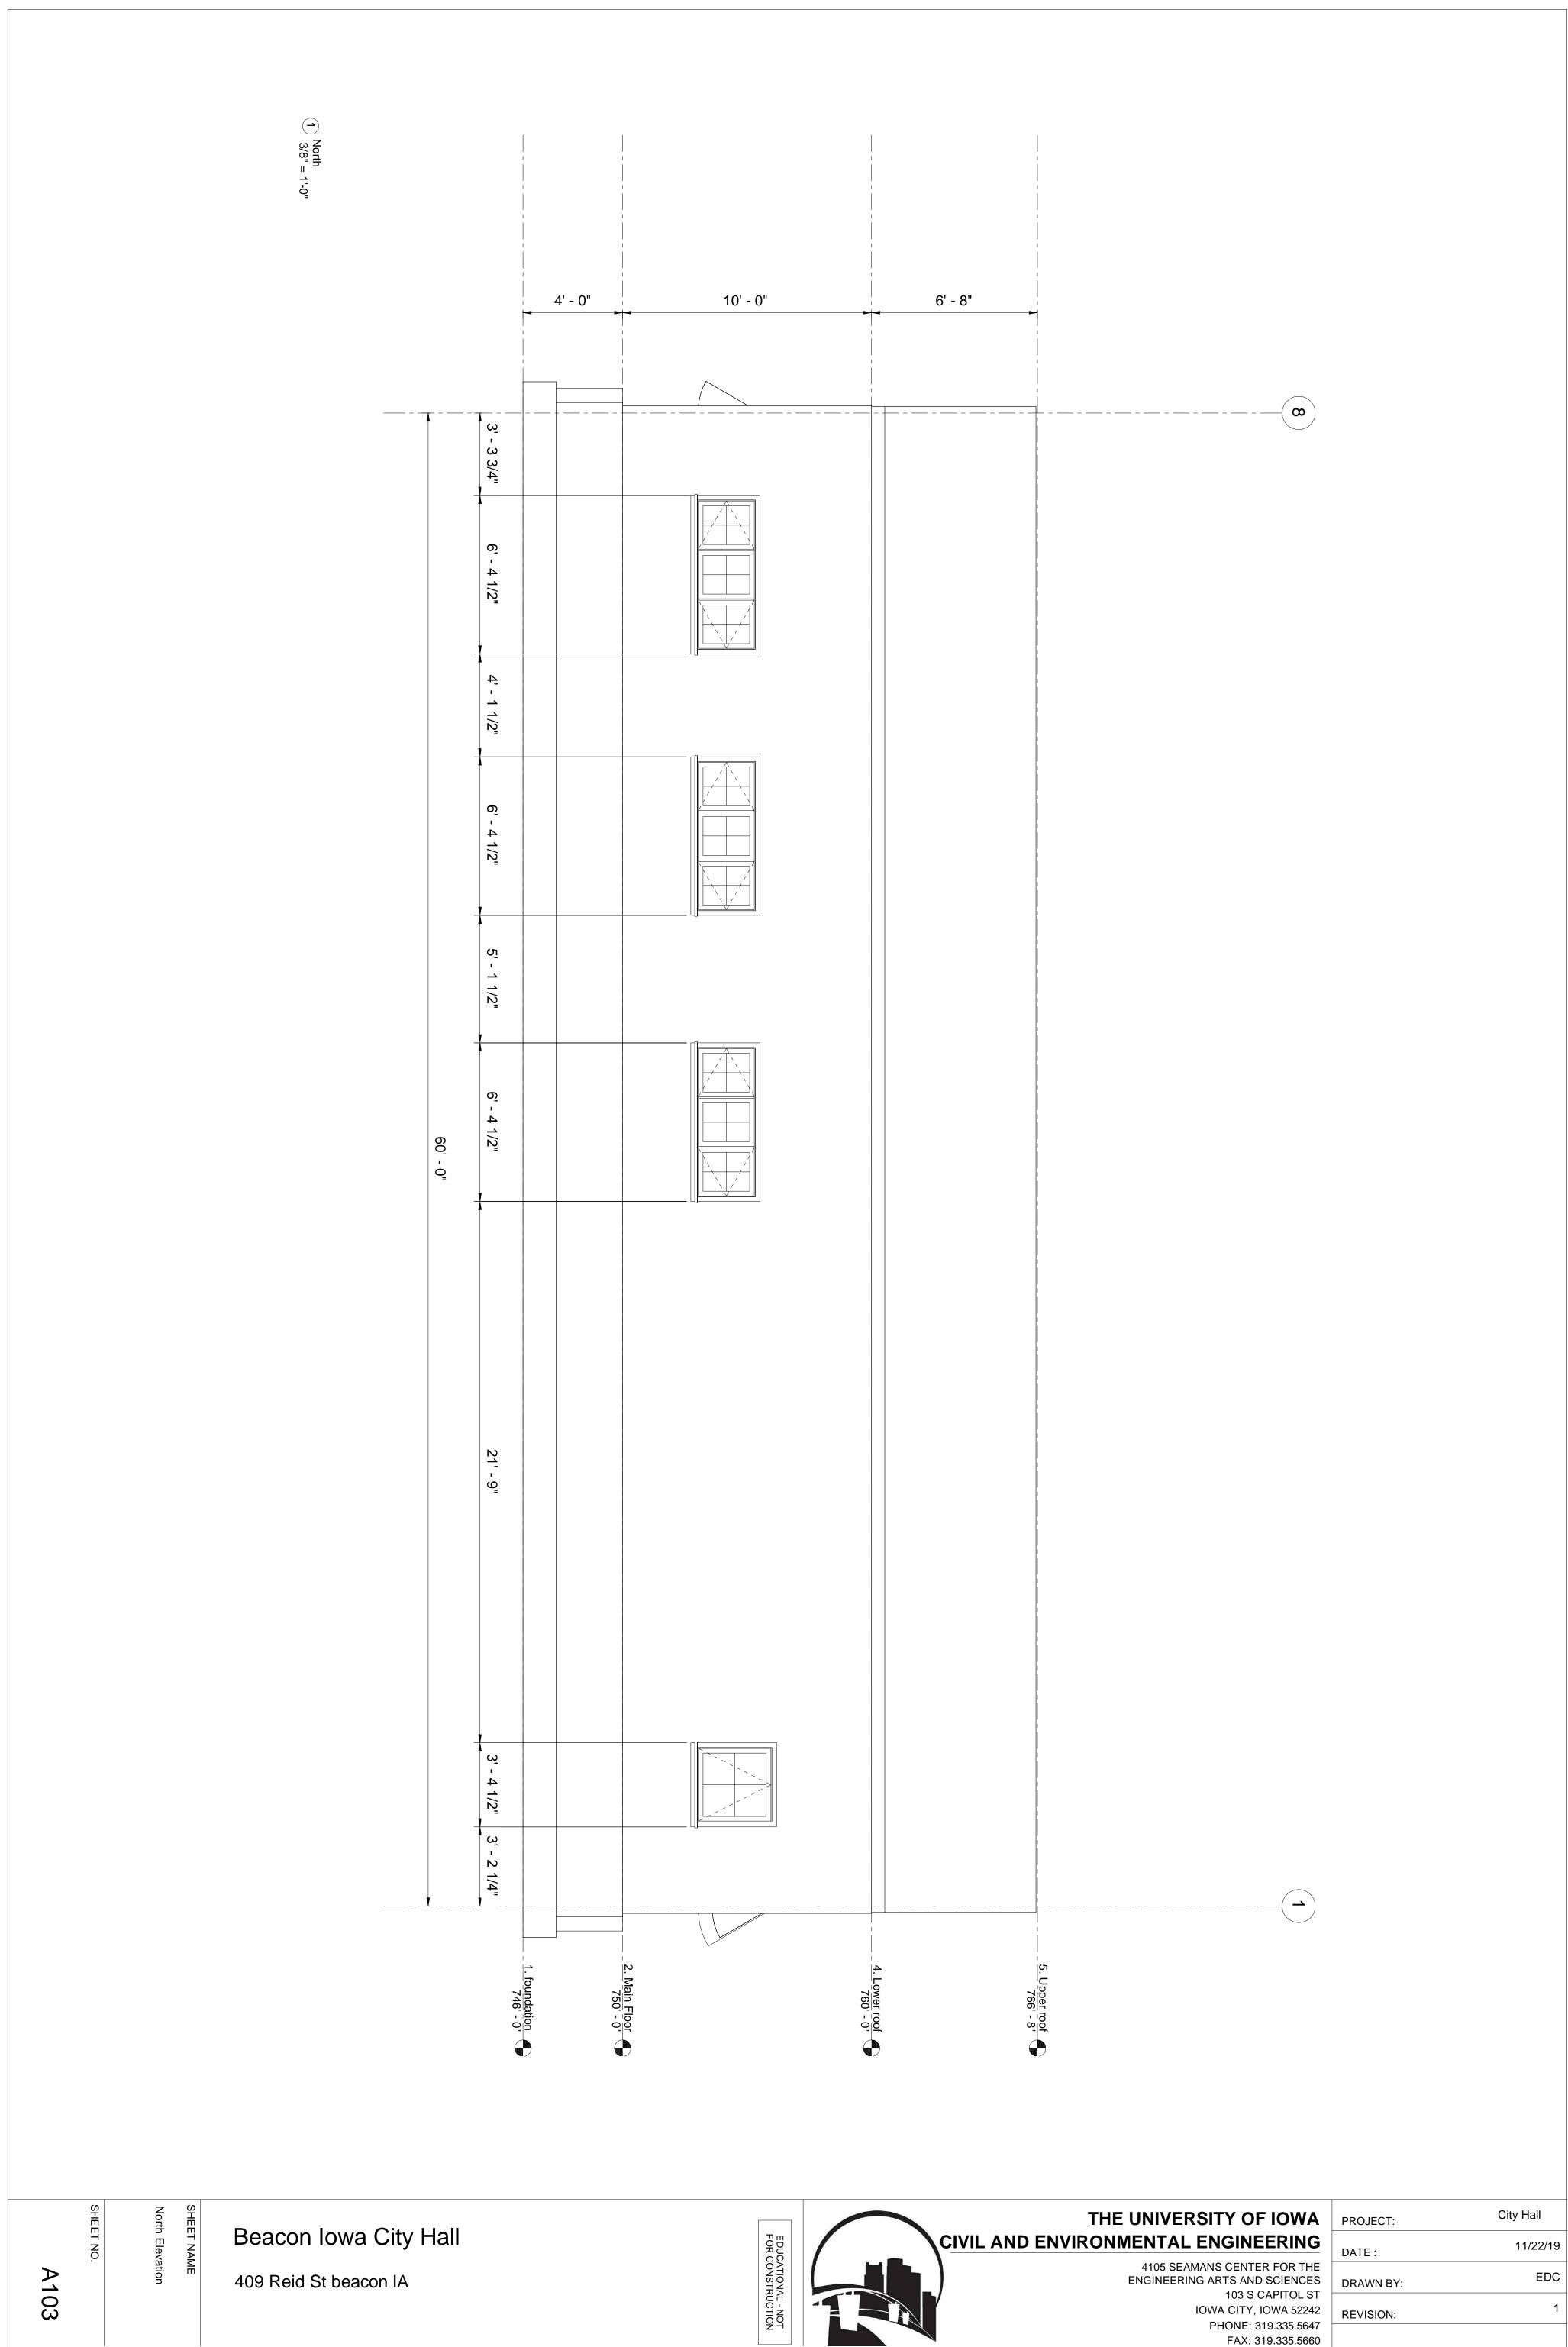
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CIVIL AND ENVIRONMENTAL ENGINEERING

4105 SEAMANS CENTER FOR THE ENGINEERING ARTS AND SCIENCES 103 S CAPITOL ST IOWA CITY, IOWA 52242 PHONE: 319.335.5647 FAX: 319.335.5660

EMAIL: civil-hawks@uiowa.edu


| A | PROJECT: | City Hall |
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Architectural Floor F
SHEET NO.

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ENGINEERING ARTS AND SCIENCES
103 S CAPITOL ST
IOWA CITY, IOWA 52242
PHONE: 319.335.5647
FAX: 319.335.5660

PROJECT:

City Hall


11/22/19

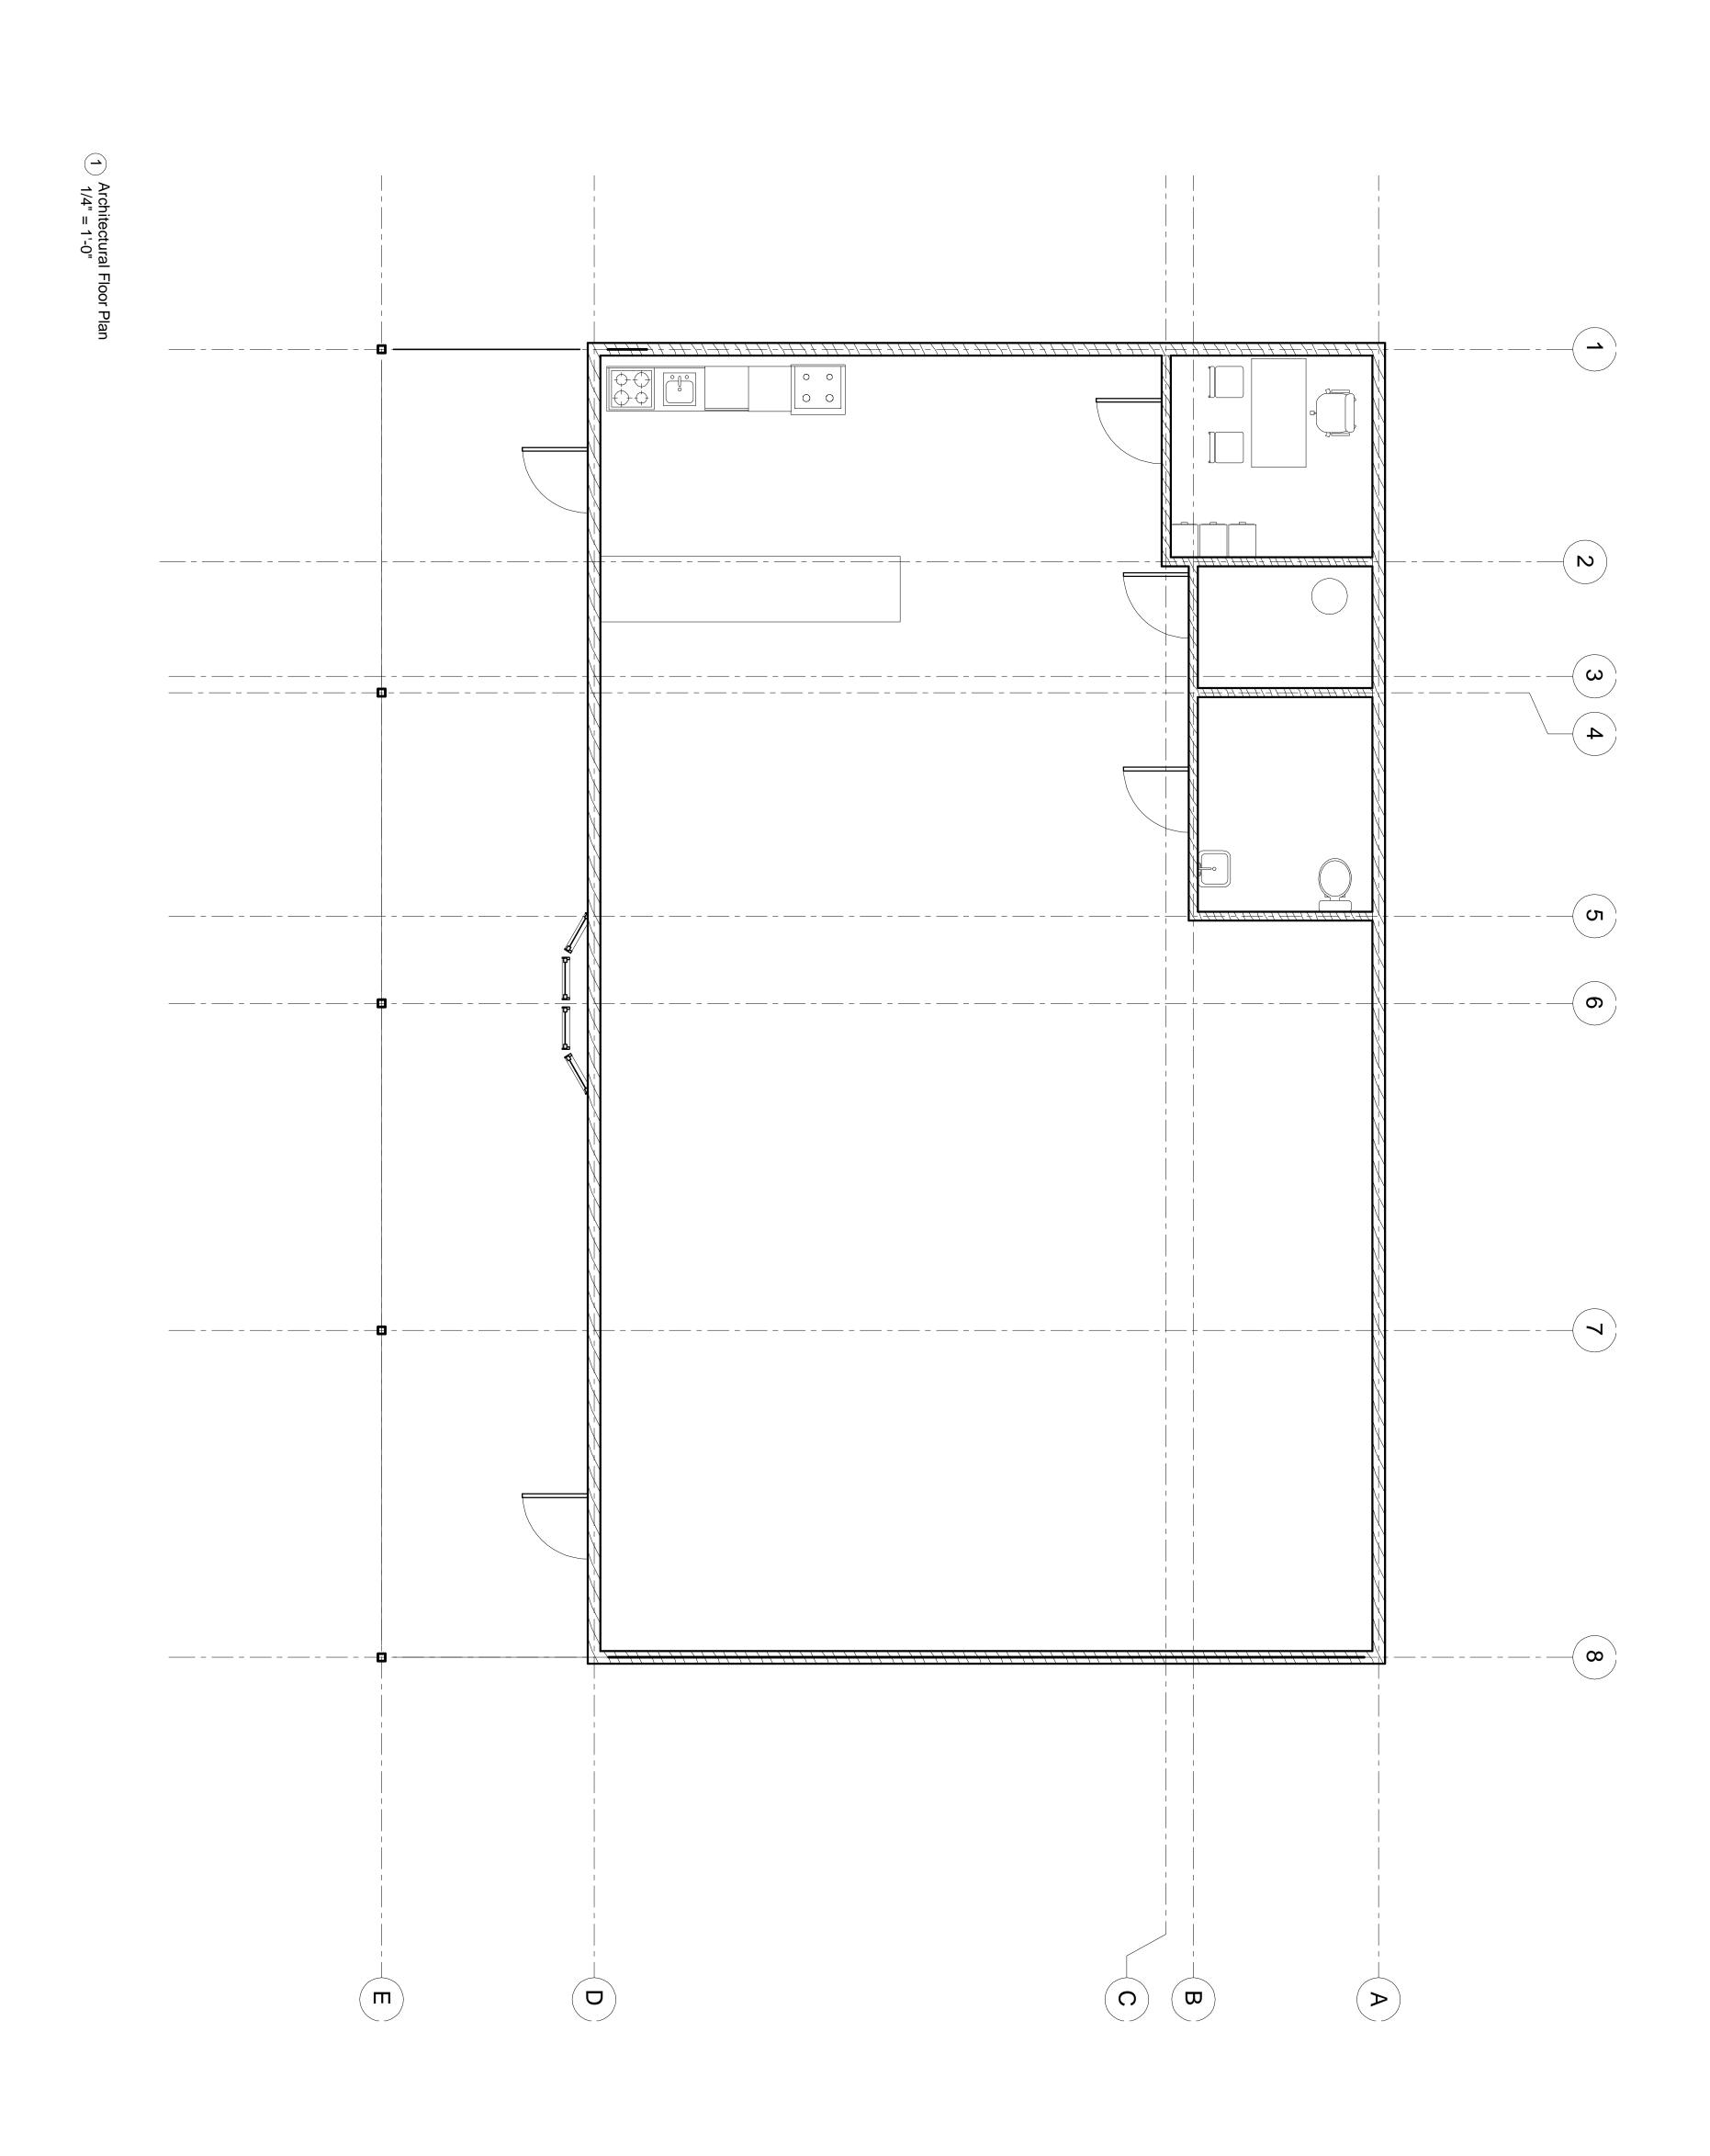
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NOTE:

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GRAPHIC SCALE (IN FEET) 1" = 20' (24x36)

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BEACON

409 REID STREET BEACON, IA 52534

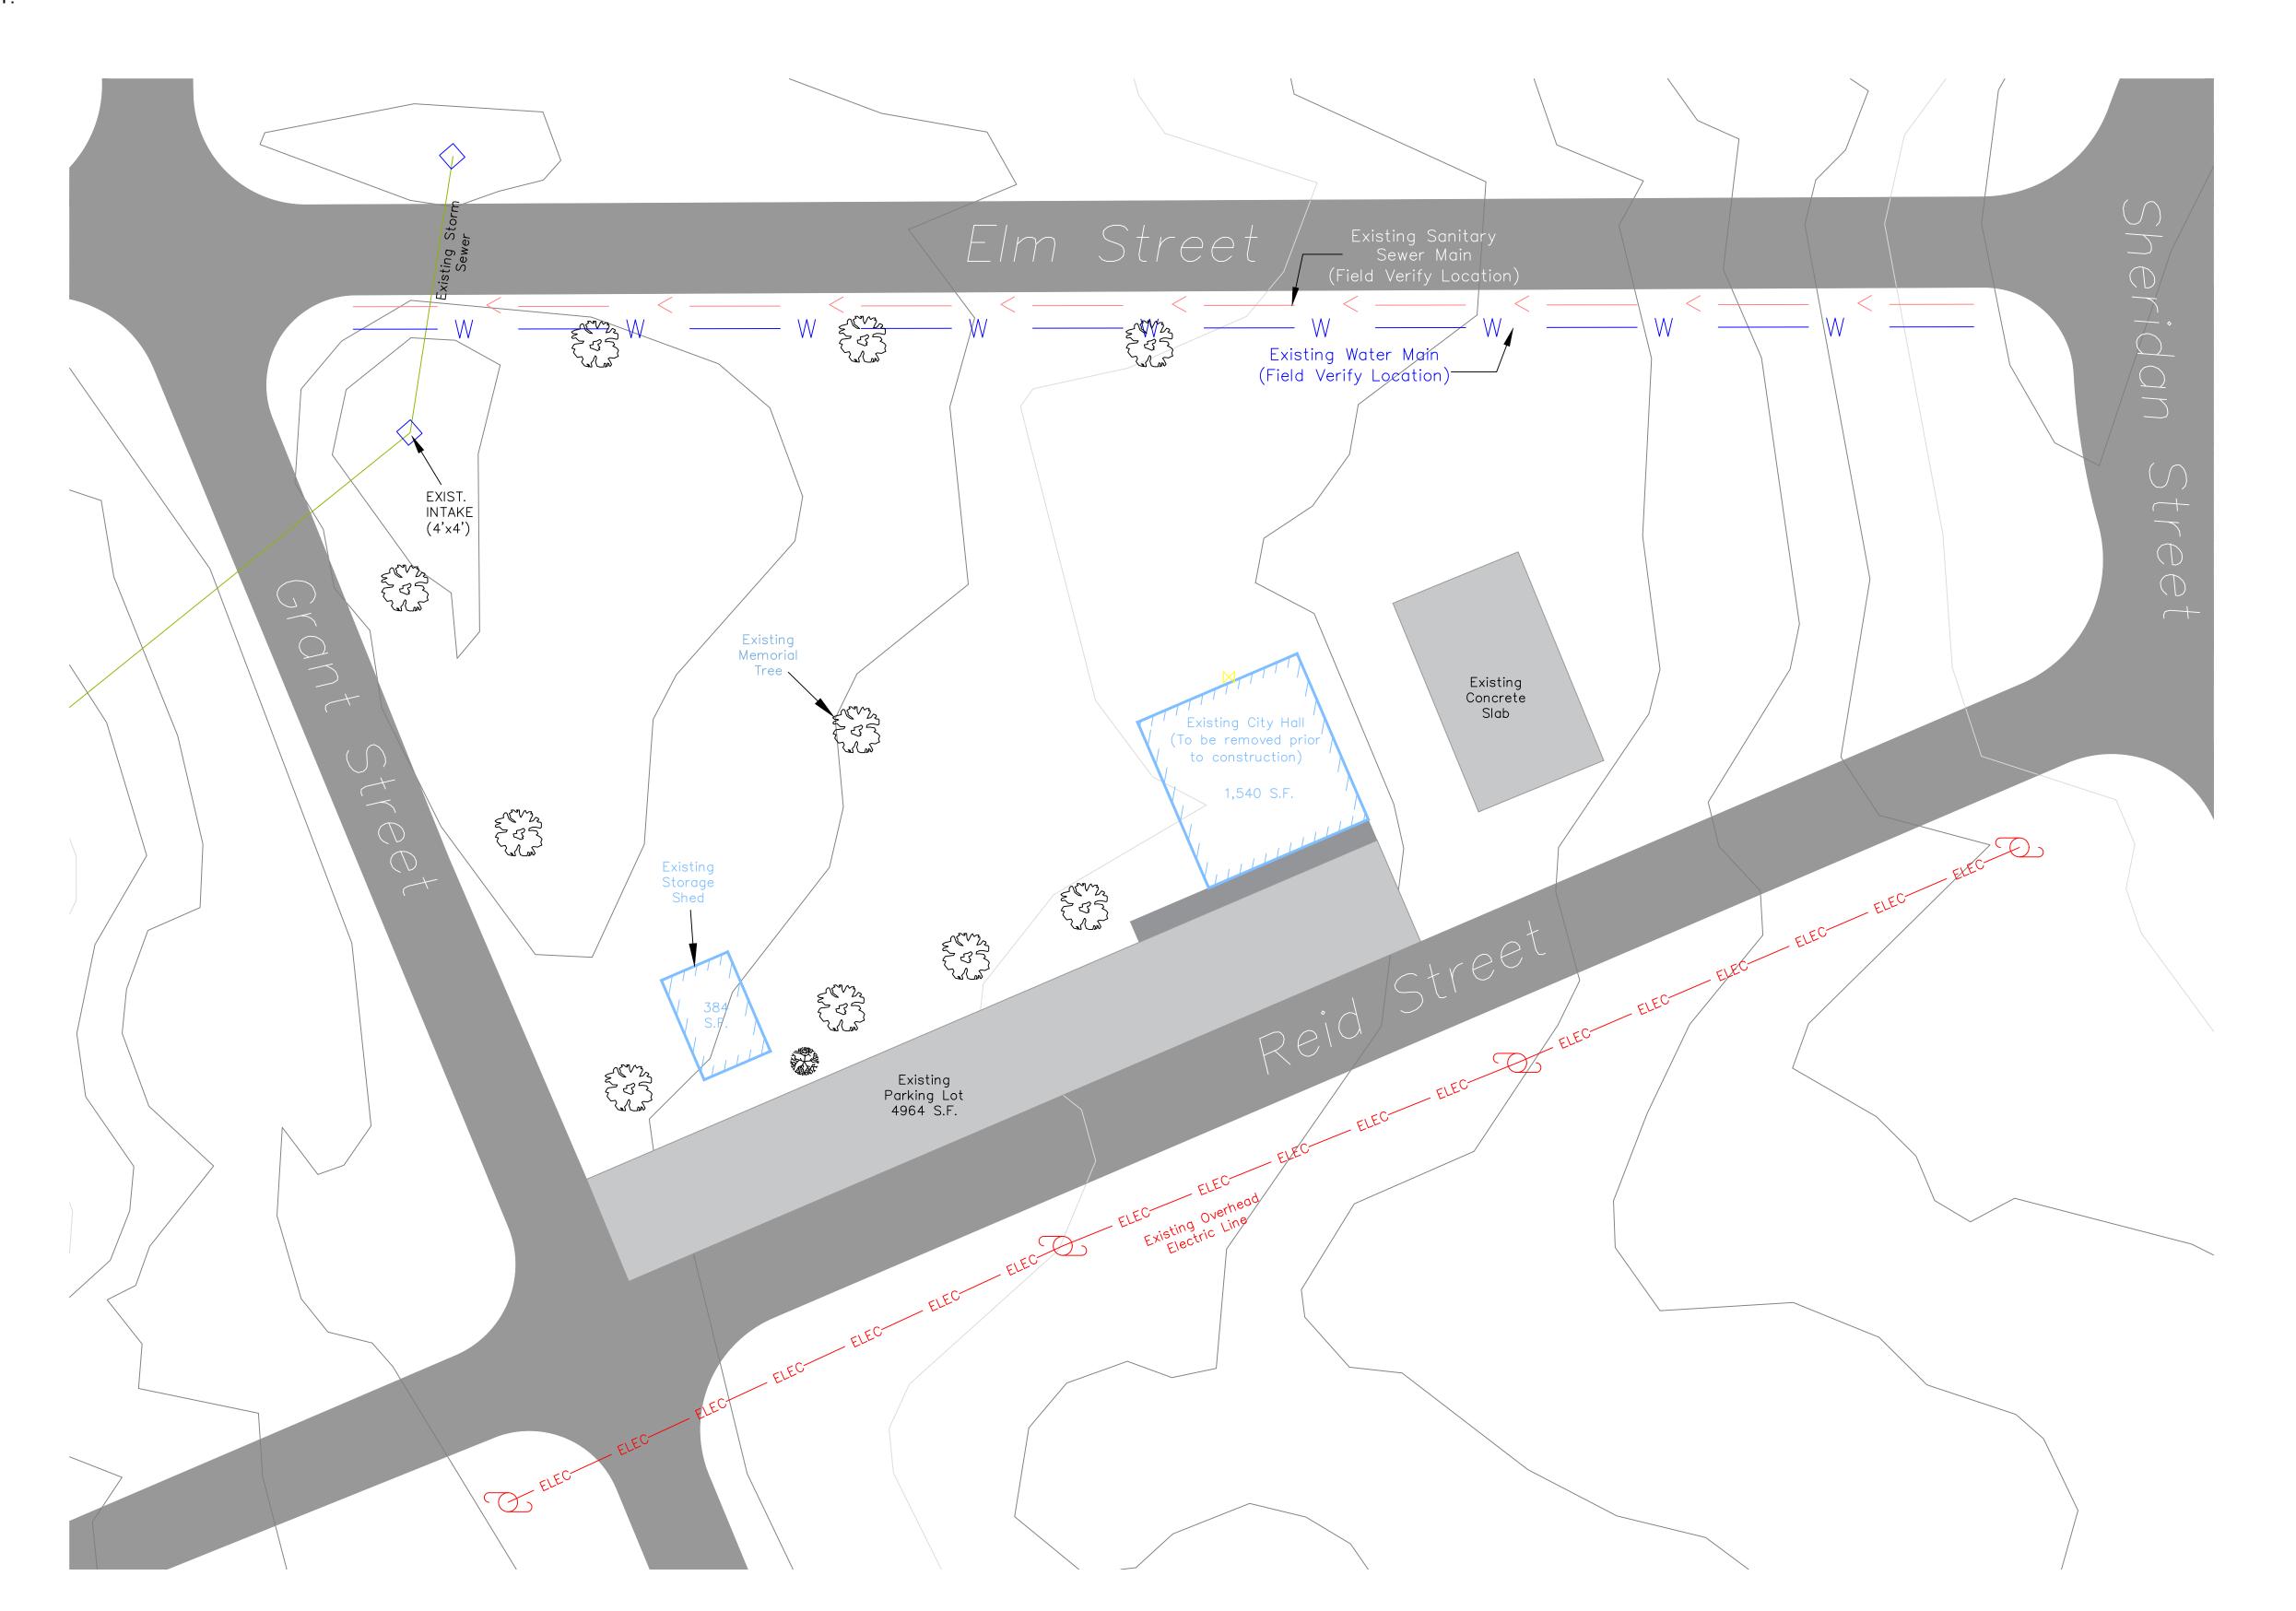SHEET NAME

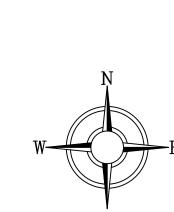EXISTING CONDITIONS

SHEET NO.

NOTE:

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| <u>LEGEND:</u> | | | | |
|----------------|---|----------------|--|--|
| | EXISTING SANITARY PROPOSED SANITARY EXISTING STORM SEWER PROPOSED STORM SEWER EXISTING WATER PROPOSED WATER EXISTING GAS LINE EXISTING ELECTRIC | × 6 ↔ 6 | EXISTING GAS VALVE EXISTING UTILITY POLE EXISTING LIGHT POLE EXISTING TREE EXISTING BUSH | |
| | | | | |

P.C.C PAVING

- 1. CONCRETE SHALL HAVE MINIMUM 28-DAY COMPRESSIVE STRENGTH OF 4000 PSI.
- 2. ALL WORK TO COMPLY WITH CURRENT ACI STANDARDS
- 3. THE CONTRACTOR SHALL PAINT PARKING STALLS AND PROVIDE AND INSTALL ADA PARKING SIGNS.
- 4. ALL DEBRIS SPILLED ON THE CITY STREETS OR ADJACENT PROPERTY SHALL BE PROMPTLY REMOVED BY THE CONTRACTOR.





DENOTES 6" P.C.C ON 12" PREPARED SUBGRADE



DENOTES 4" MIN. SIDEWALK ON 4" SUBGRADE



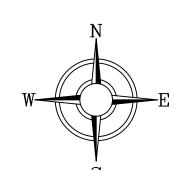

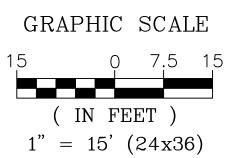

409 REID STREET BEACON, IA 52534 **BEACON**

C

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SHEET NAME SITE PLAN


GEOMETRY


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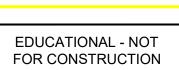






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CIVIL

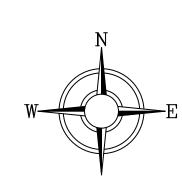

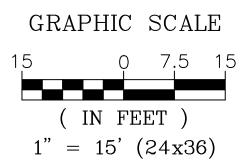Beacon City Hall

409 REID STREET BEACON, IA 52534


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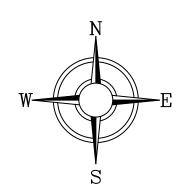
GRADING PLAN


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Beacon City Hall

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SHEET NAME

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STORMWATER **RUNOFF PLAN**

SHEET NO.

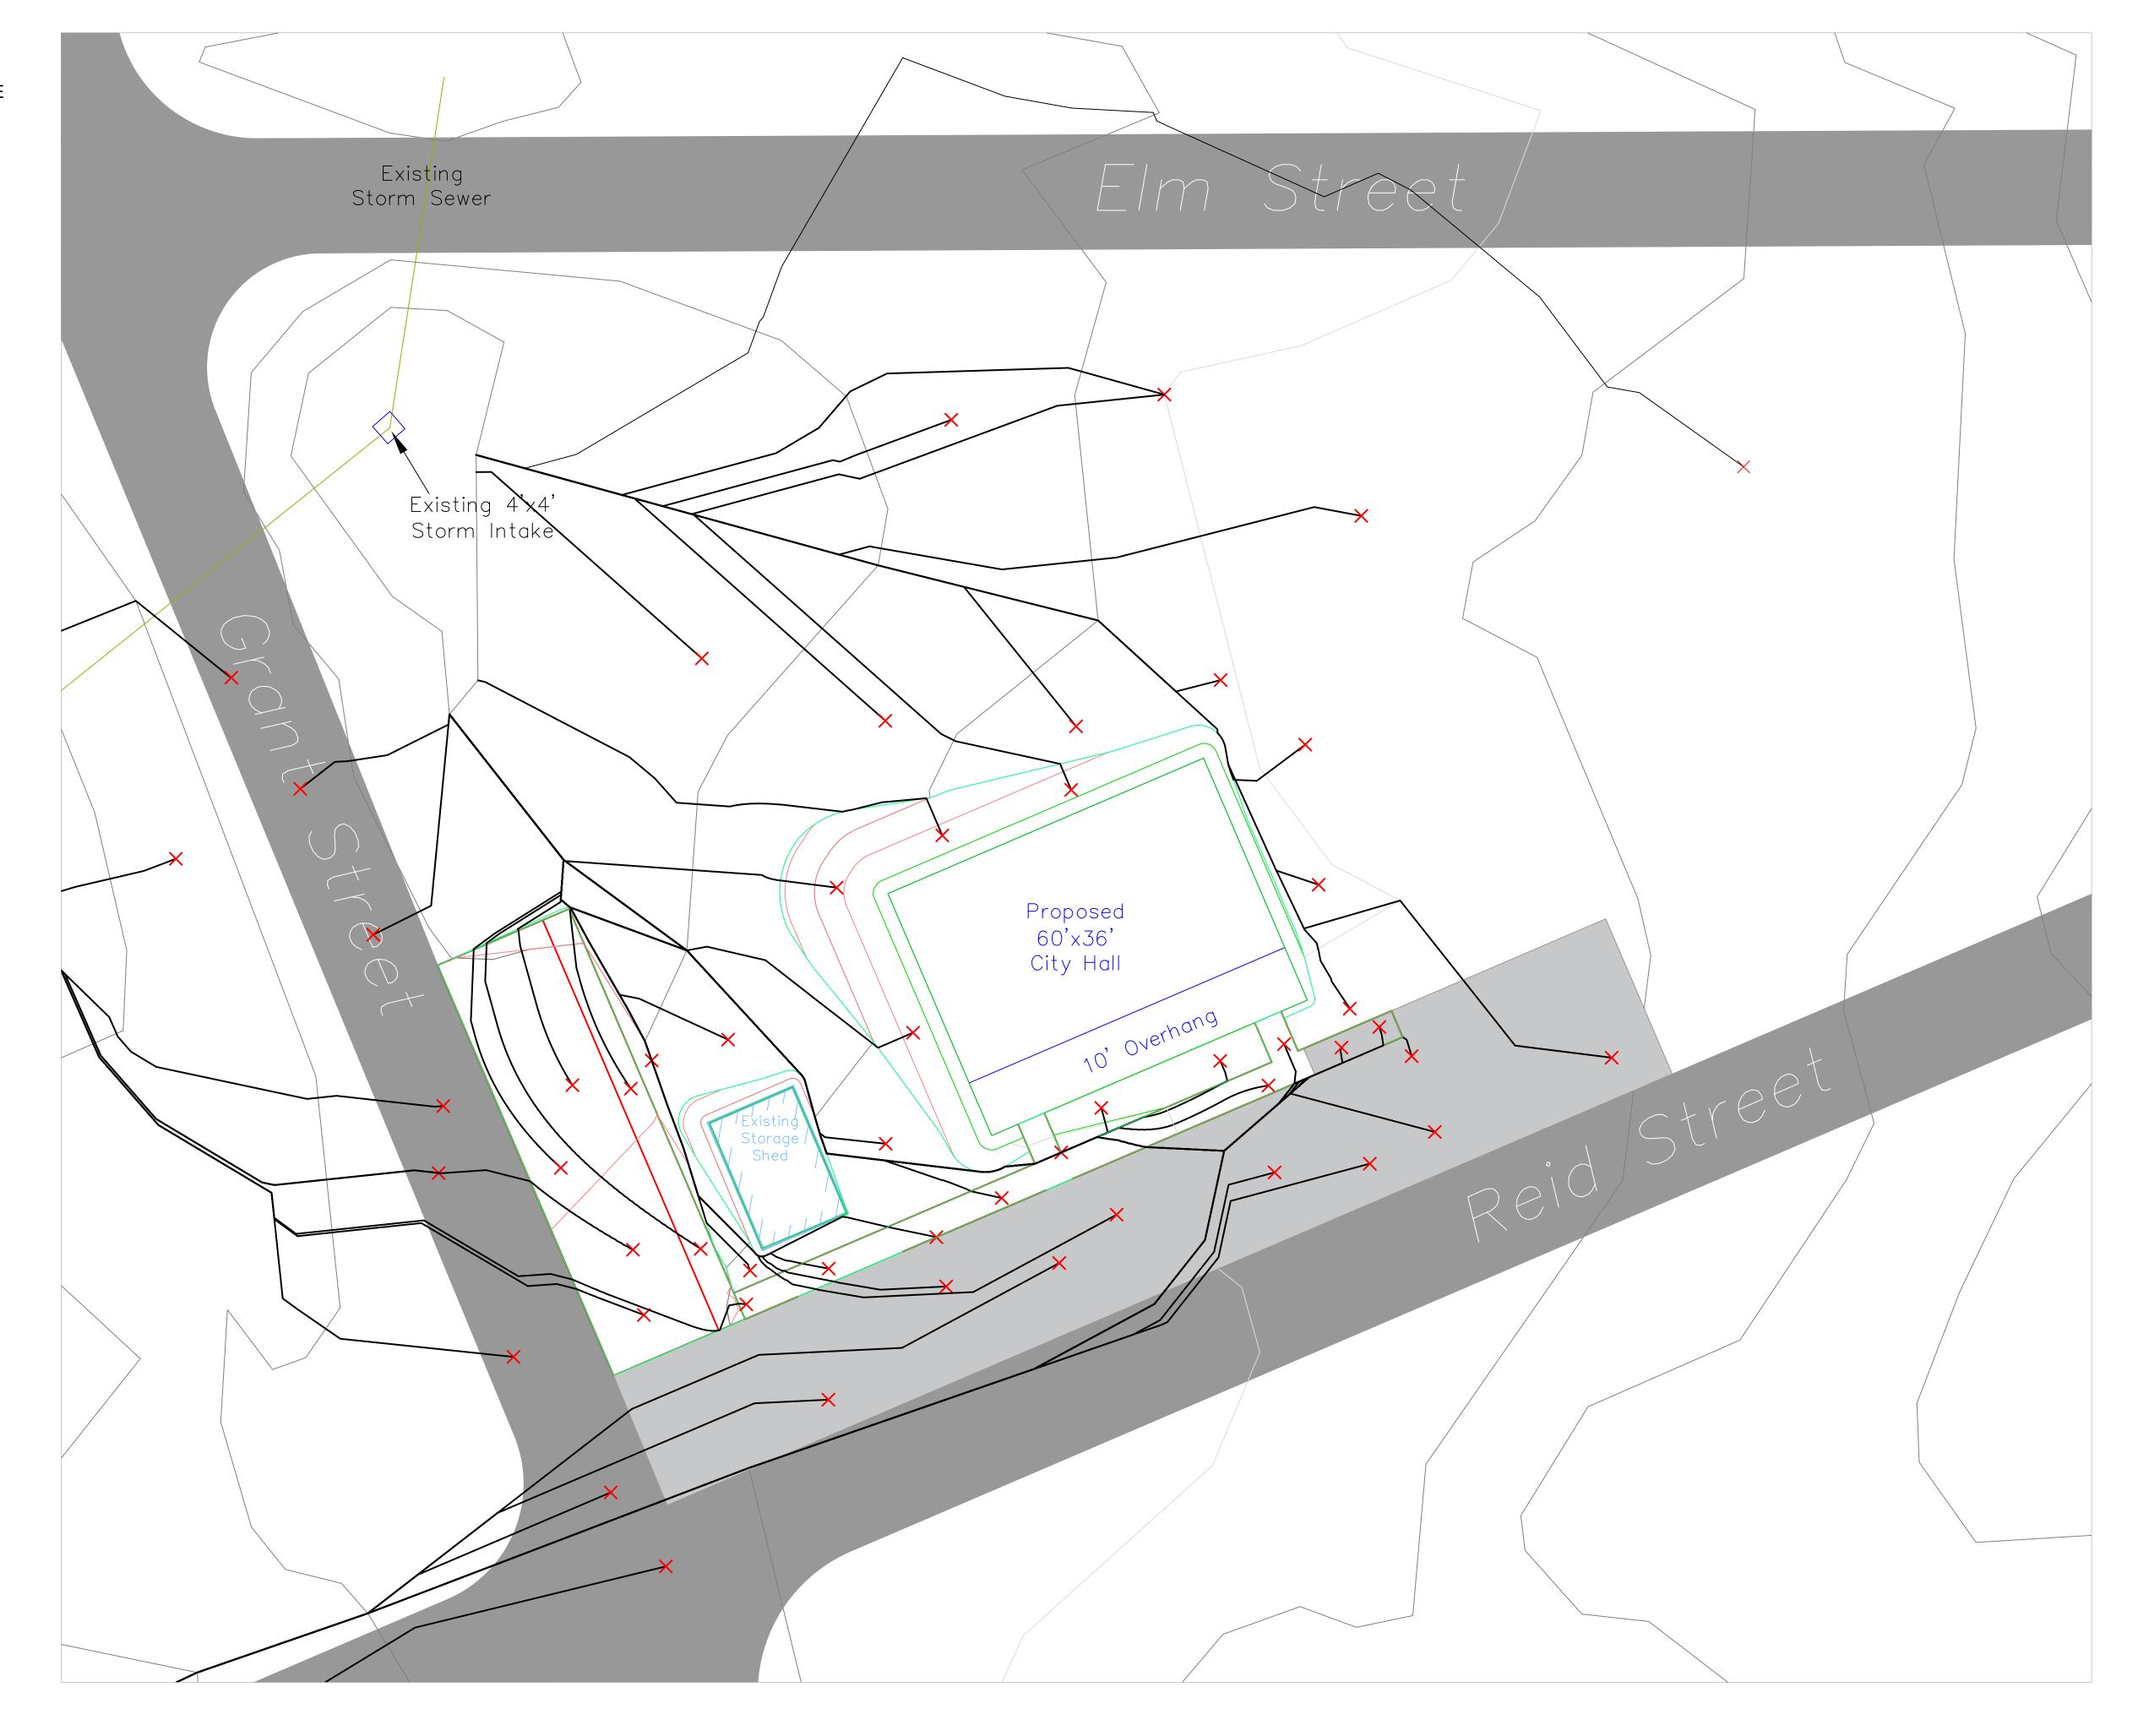NOTE:
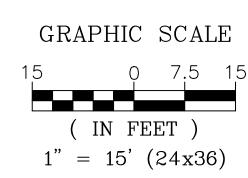
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All sanitary sewer, storm sewer, water service and paving shall be constructed in conformance with the current standards and specifications of the State of Iowa


| <u>LEGEND:</u> | | | |
|----------------|---|-----|--|
| | EXISTING SANITARY PROPOSED SANITARY EXISTING STORM SEWER PROPOSED STORM SEWER EXISTING WATER PROPOSED WATER EXISTING GAS LINE EXISTING ELECTRIC | (C) | EXISTING GAS VALVE EXISTING UTILITY POLE |


SANITARY SEWER:


1. THE CONTRACTOR SHALL INSTALL ANY AND ALL FITTING AND APPURTENANCE AS REQUIRED BY STATE PLUMBING CODE WHETHER SHOWN OR NOT.

WATER SERVICE:

- 1. CONTRACTOR SHALL ARRANGE FOR ANY REQUIRED TAPS TO MAINS.
- 2. CONTRACTOR SHALL COMPLY WITH ALL STATE CODES.

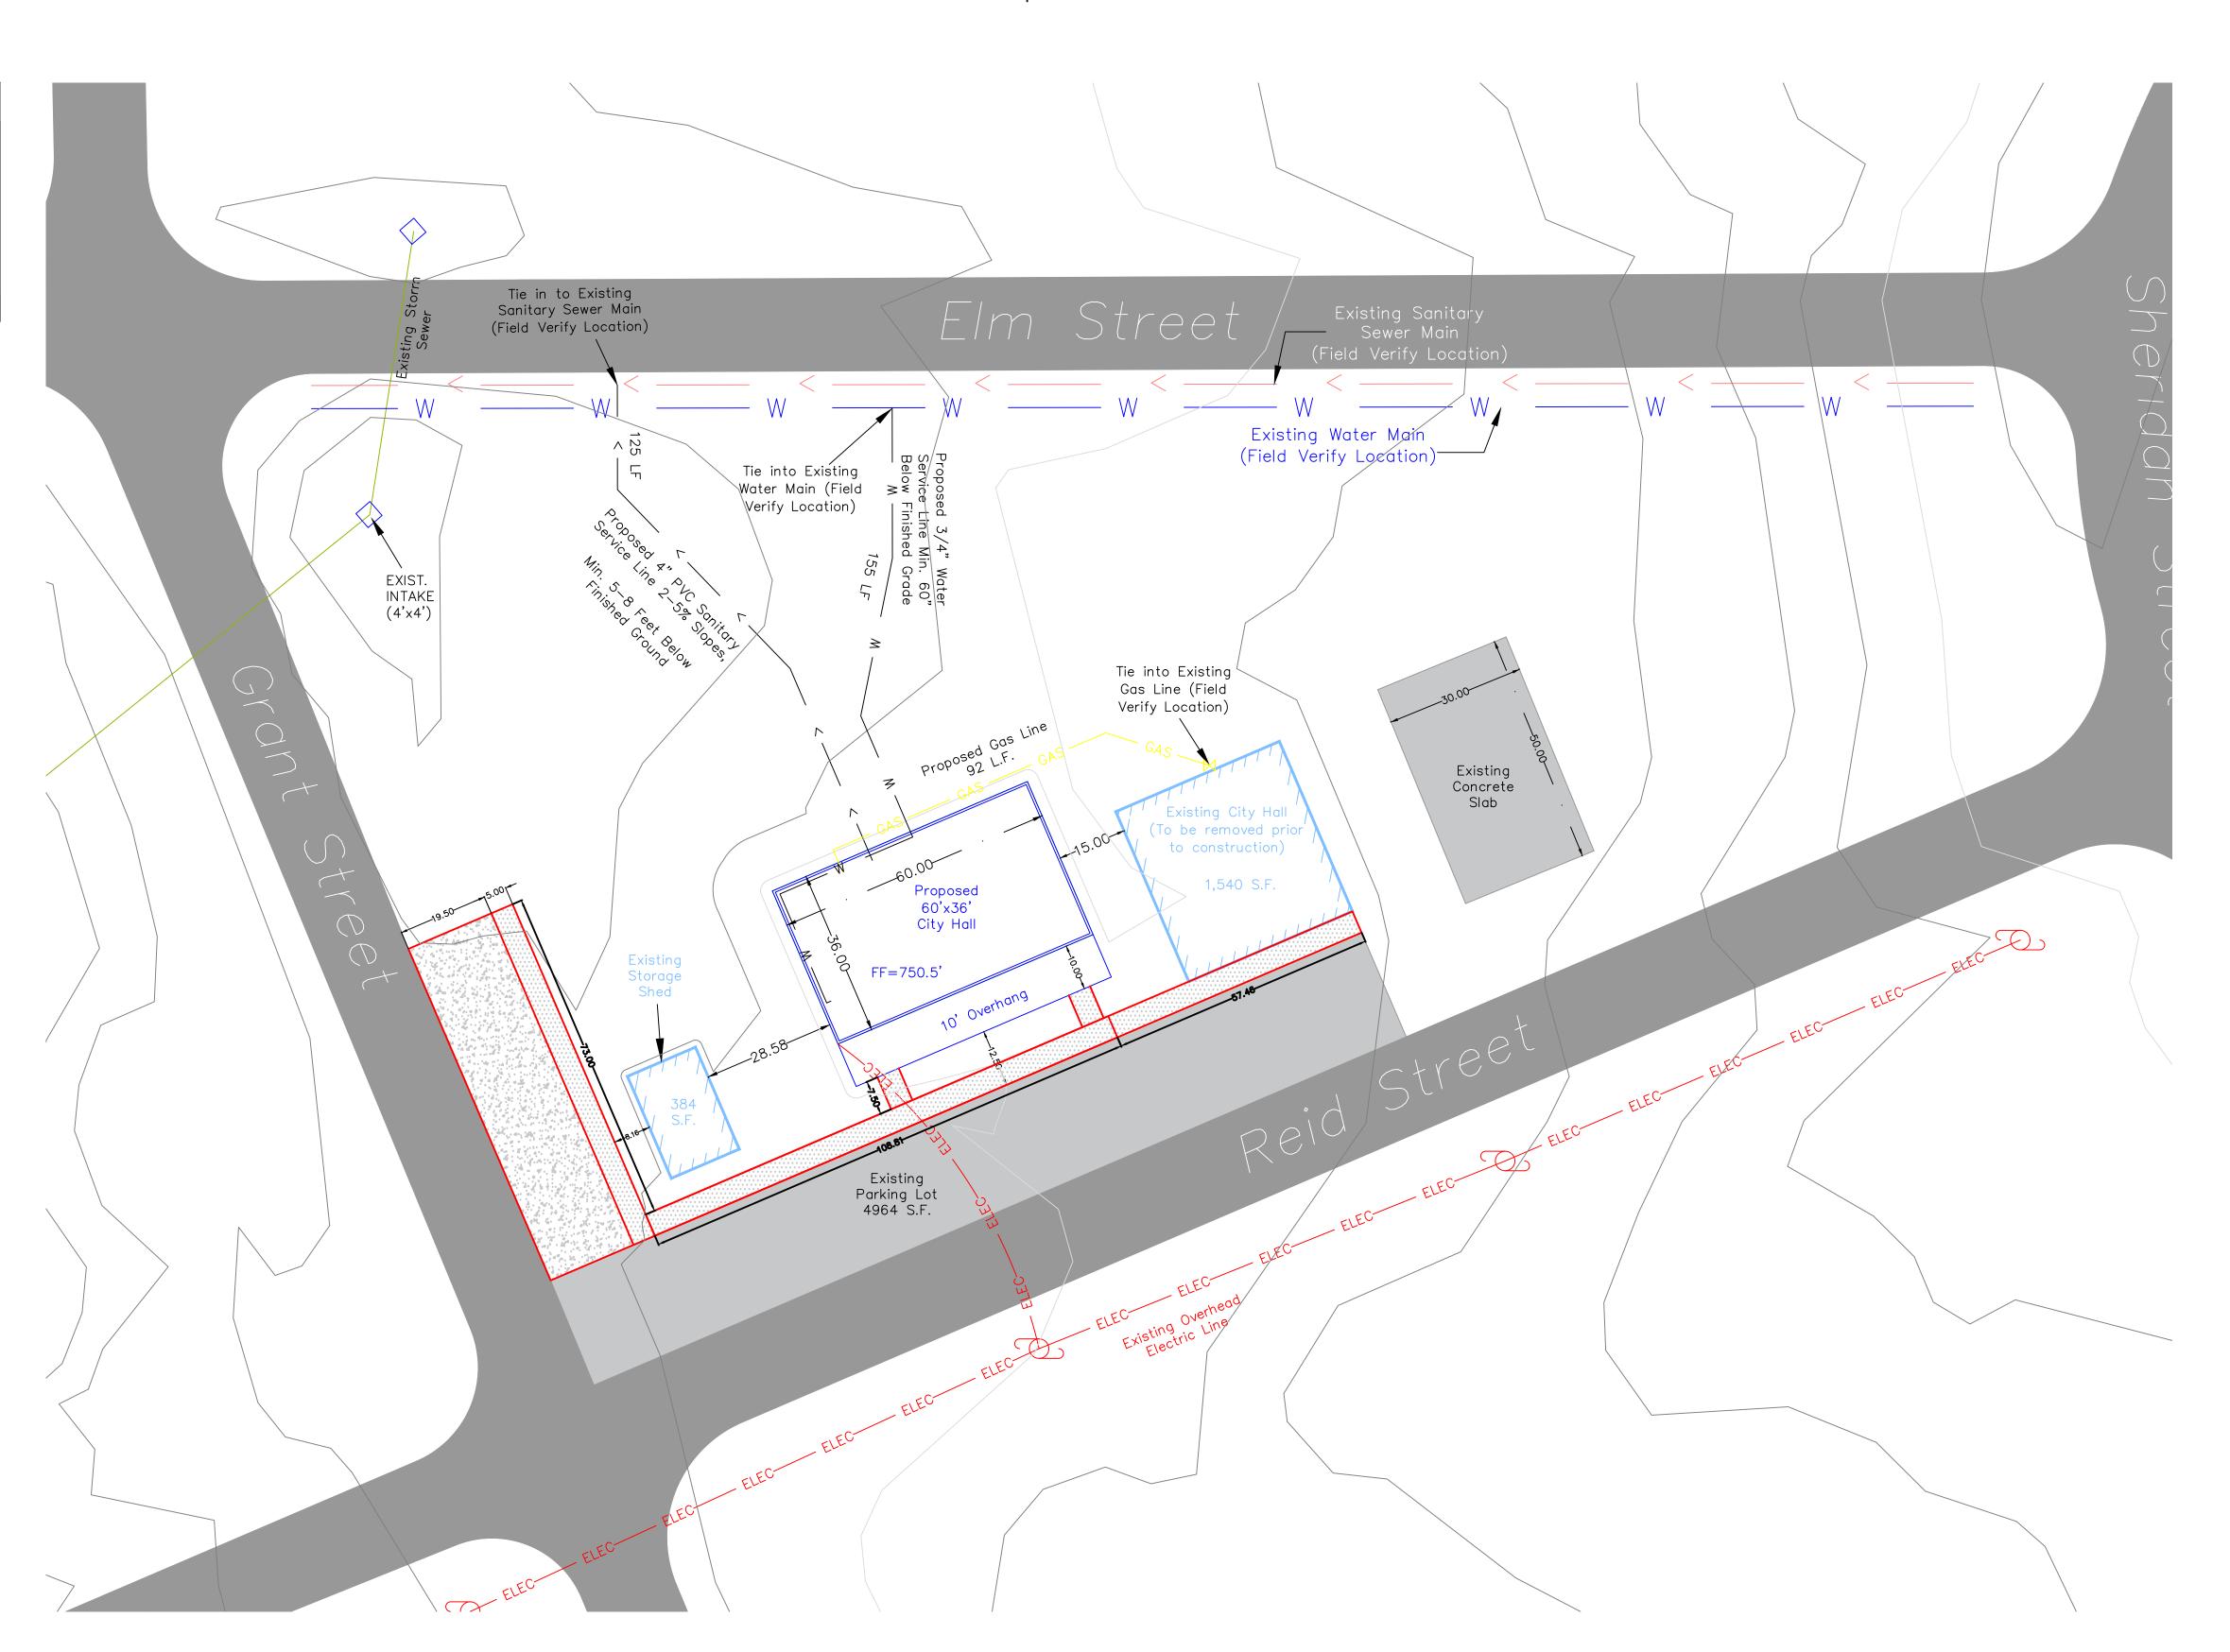

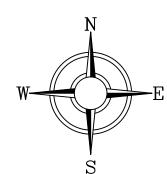

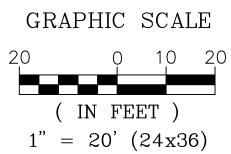

BEACON

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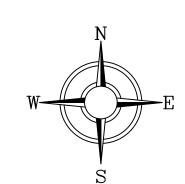
SHEET NAME

UTILITY PLAN

SHEET NO.

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GRAPHIC SCALE (IN FEET) 1" = 15' (24x36)

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NAME **PROJECT**

409 REID STREET BEACON, IA 52534

SHEET NAME

EROSION CONTROL PLAN


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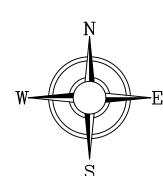
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GENERAL DEMOLITION NOTES

- 1. CONTRACTOR SHALL FIELD VERIFY ALL EXISTING CONSTRUCTION-RELATED. CONDITIONS PRIOR TO STARTING DEMOLITION OR NEW CONSTRUCTION.
- 2. ALL DEMOLITION AND CONSTRUCTION ACTIVITIES SHALL BE COORDINATED WITH THE OWNER TO MINIMIZE DISRUPTION OF THE NORMAL DAILY FUNCTIONING OF THE OWNERS OCCUPIED AREAS.
- 3. OWNER WILL RETAIN ALL SALVAGE THAT IS OF VALUE AS DESIGNATED BY THE OWNERS REPRESENTATIVE, EXCEPT THOSE ITEMS DESIGNATED TO BE REUSED.
- 4. THE CONTRACTOR SHALL BE RESPONSIBLE FOR REMOVING FROM THE PREMISES ALL CONSTRUCTION DEBRIS AND ITEMS NOT REUSED OR RETAINED BY THE OWNER.
- 5. TEMPORARY BARRICADES AS PERTAINING TO CONTRACTORS ACTIVITIES SHALL BE INSTALLED TO PREVENT POSSIBLE INJURY TO PERSONS IN AND AROUND CONSTRUCTION AREAS.





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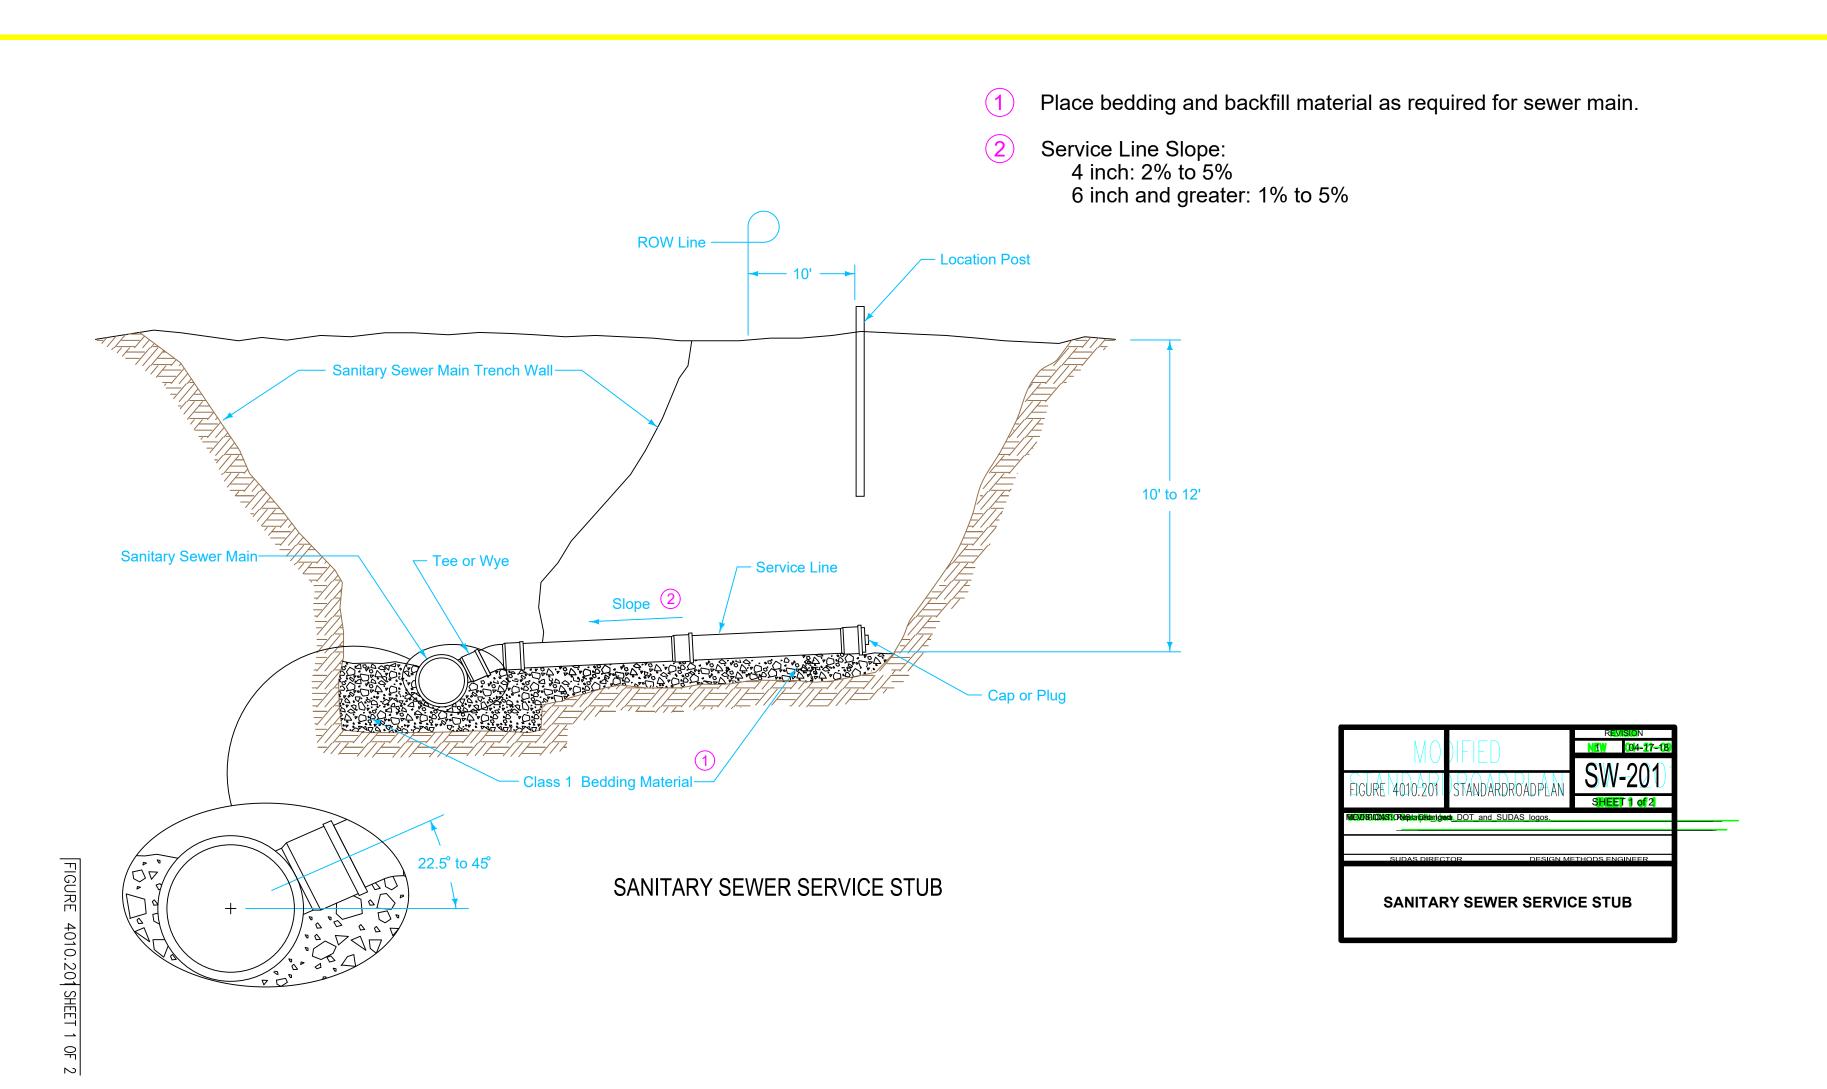
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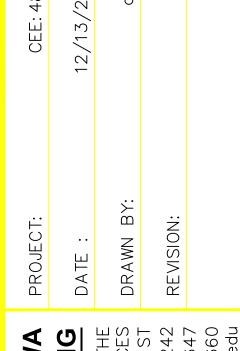
SHEET NAME

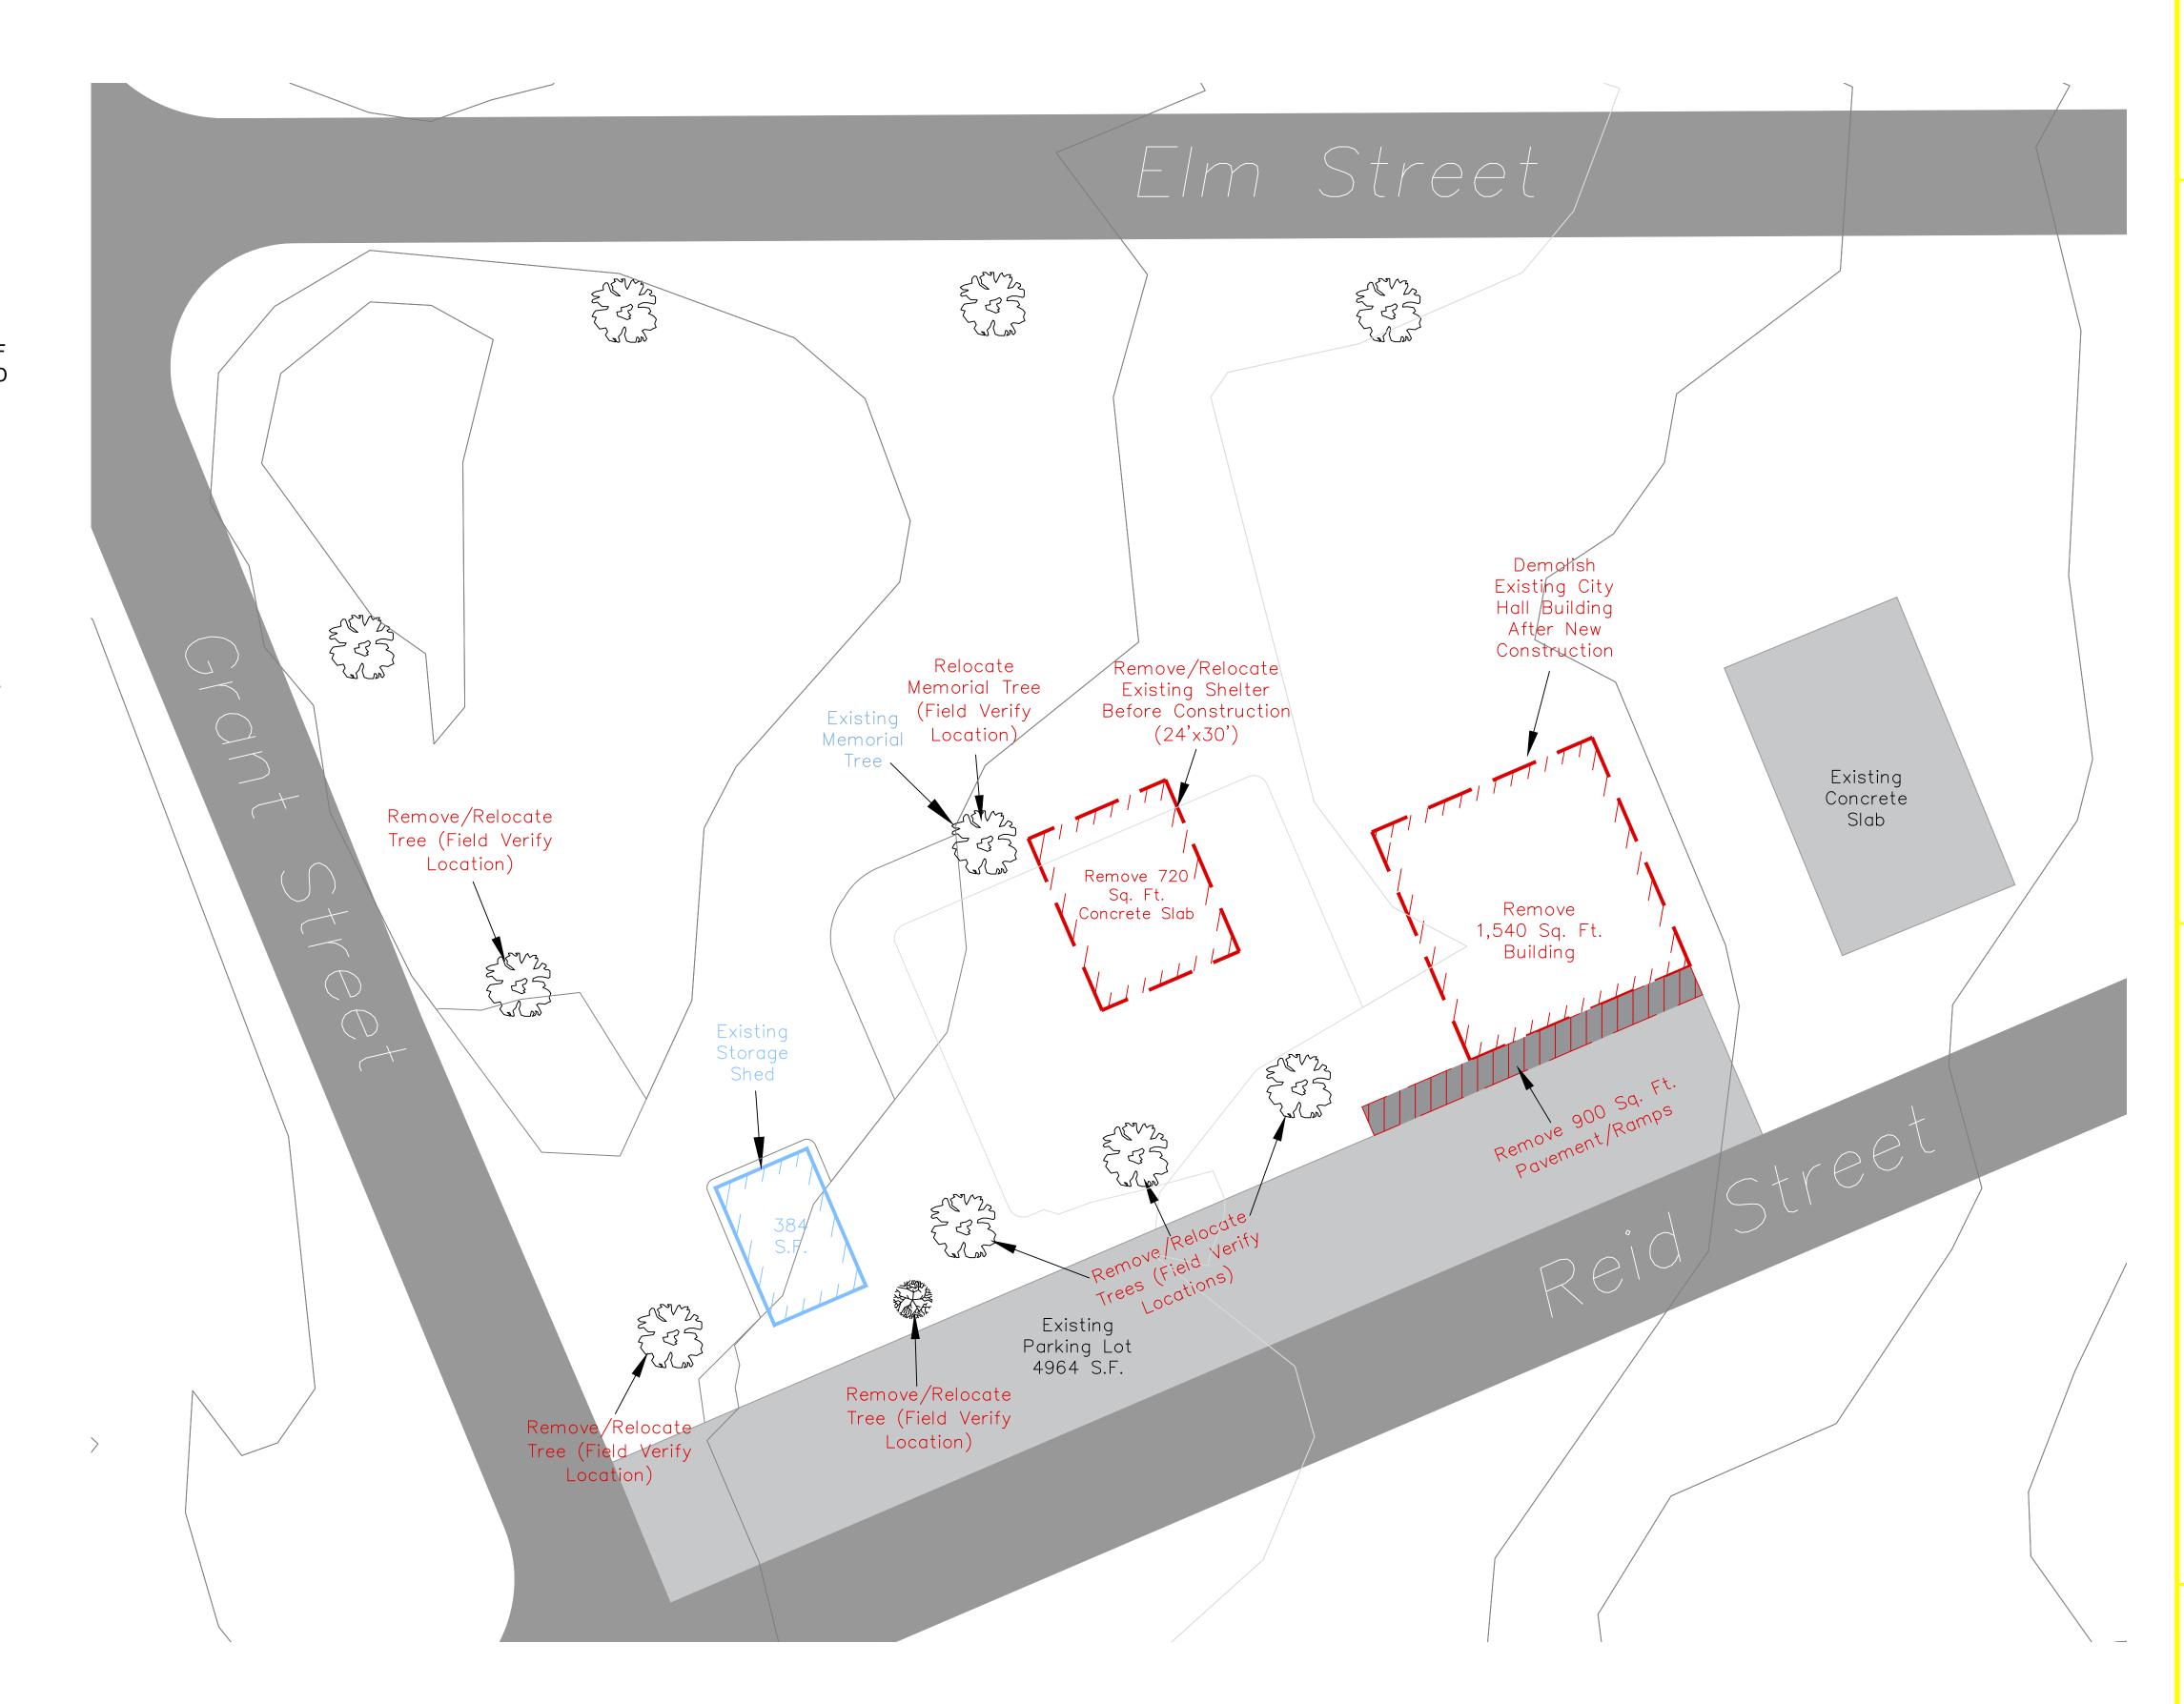DEMOLITION PLAN

SHEET NO.



DETAIL DRAWINGS NOT TO SCALE



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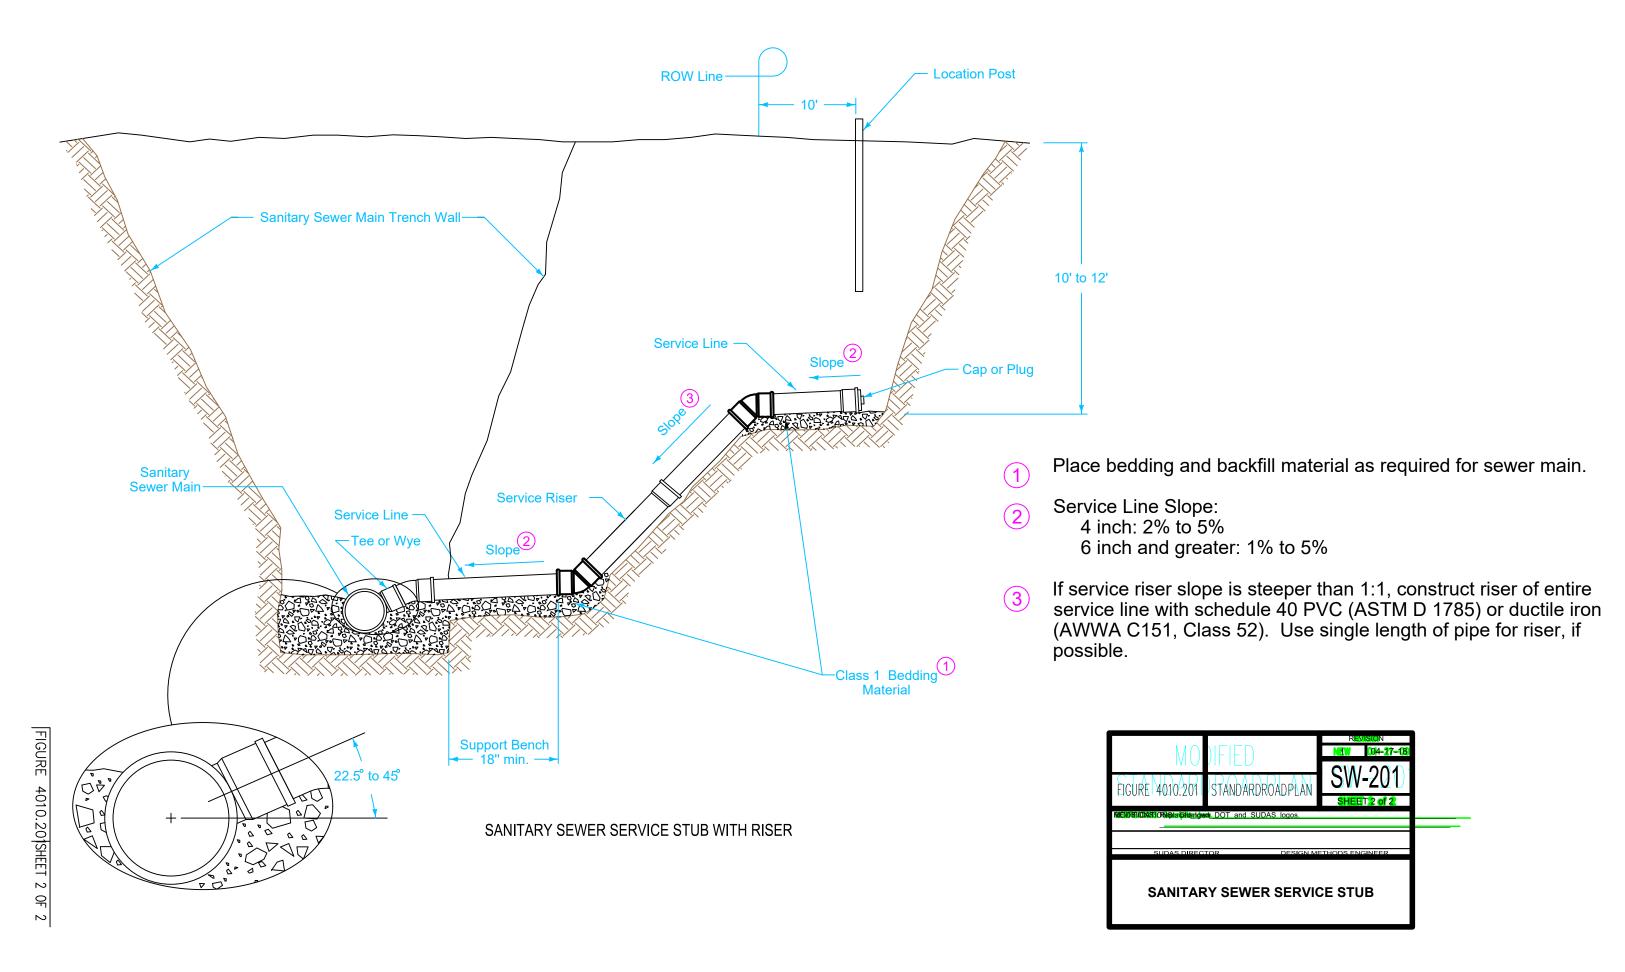
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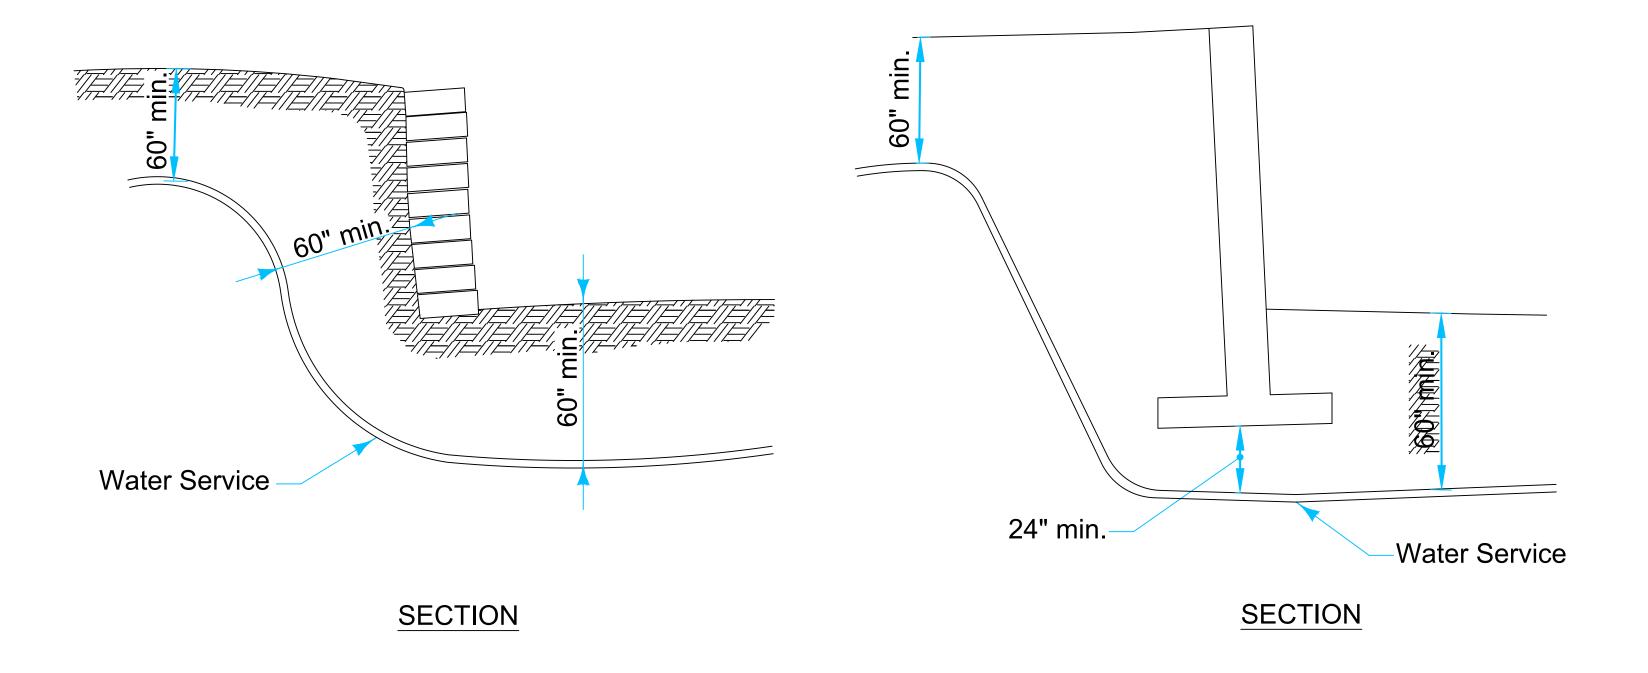
409 REID STREET BEACON, IA 52534

SHEET NAME

UTILITY DETAILS SHEET 1

SHEET NO.





This figure details minimum required clearances between structure and water service lines. Adjust location of water services as directed by the Engineer to maintain the clearances shown.

DETAIL DRAWINGS NOT TO SCALE

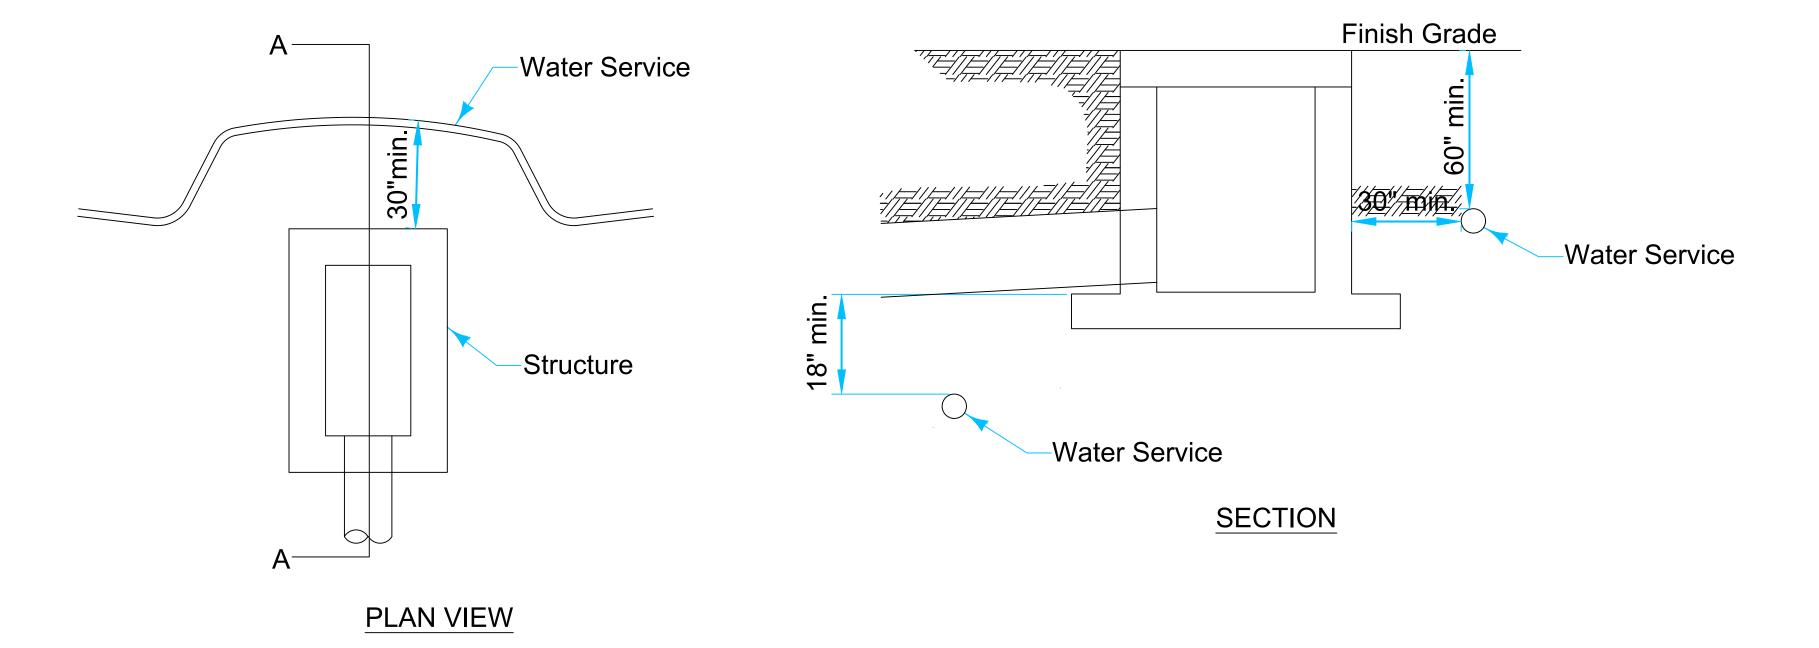


FIGURE 5010.901

SHEET 1 OF 1

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1 10-21-14

5010.901

SHEET _1 of _1

MINIMUM CLEARANCE BETWEEN WATER SERVICE AND STRUCTURE

PROJECT: CEE: 485

DATE: 12/13/20'

DRAWN BY: dm

REVISION:

AMANS CENTER FOR THE
NG ARTS AND SCIENCES
103 S CAPITOL ST
IOWA CITY, IOWA 52242
PHONE: 319.335.5647
FAX: 319.335.5660

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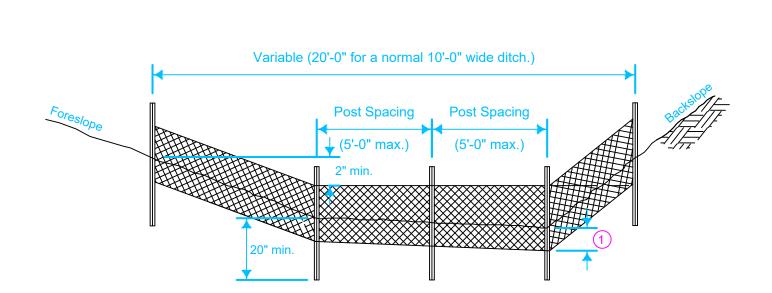
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409 REID STREET BEACON, IA 52534

SHEET NAME

UTILITY DETAILS SHEET 2

SHEET NO.




TYPICAL SILT FENCE DITCH CHECK


1 Insert 12 inches of fabric a minimum of 6 inches deep (fabric may be folded below the ground line).


PREVISION 2 10-21-14

SILT FENCE

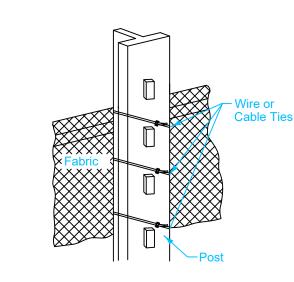


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TYPICAL PLACEMENT OF BERM OR SOCK
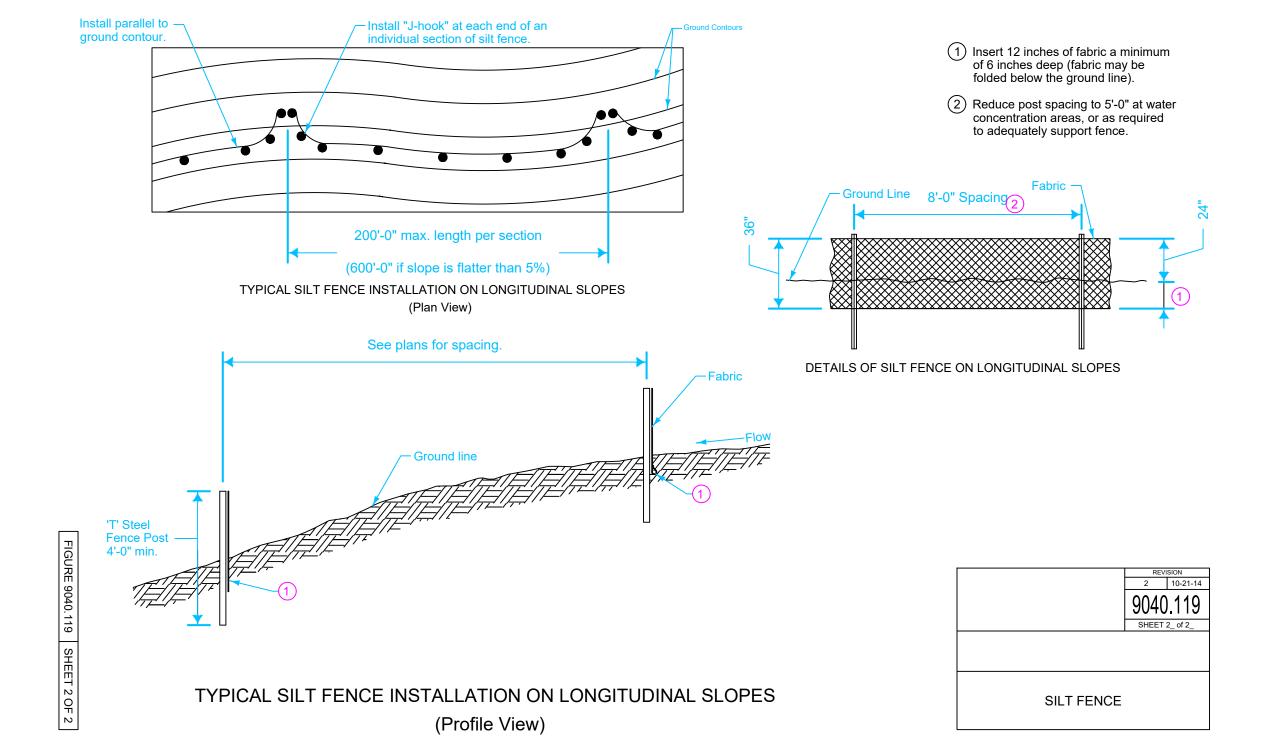
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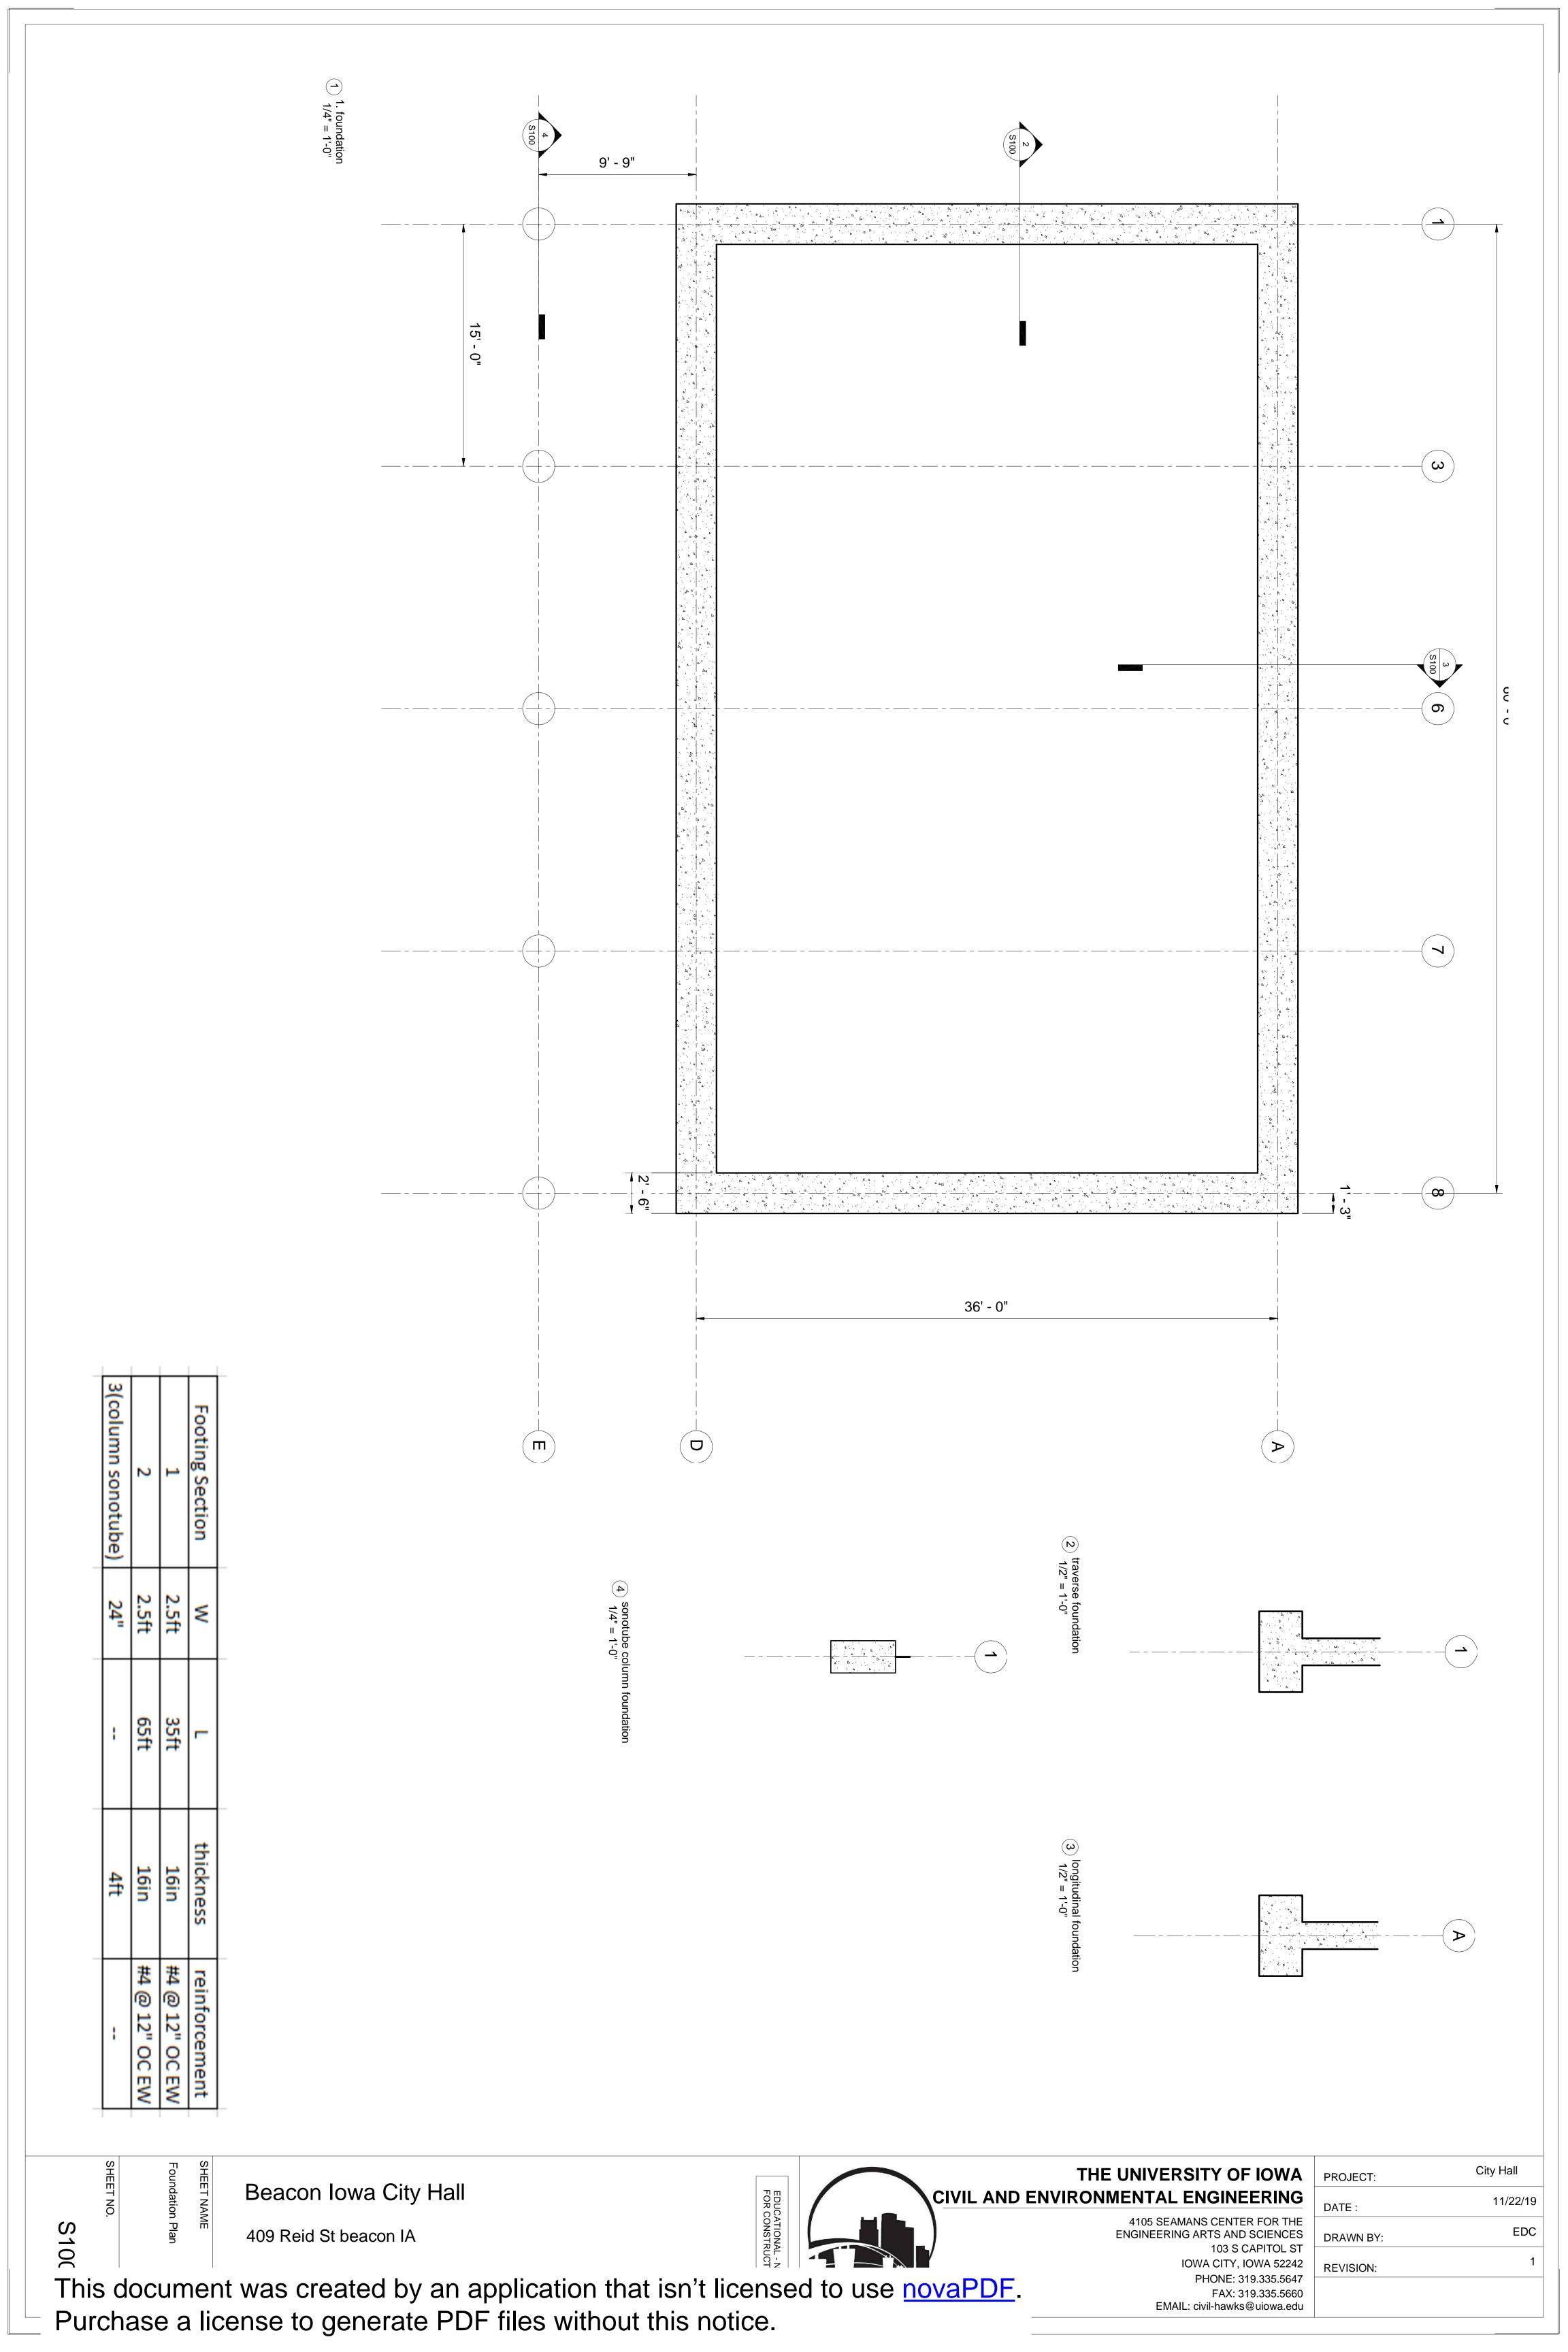
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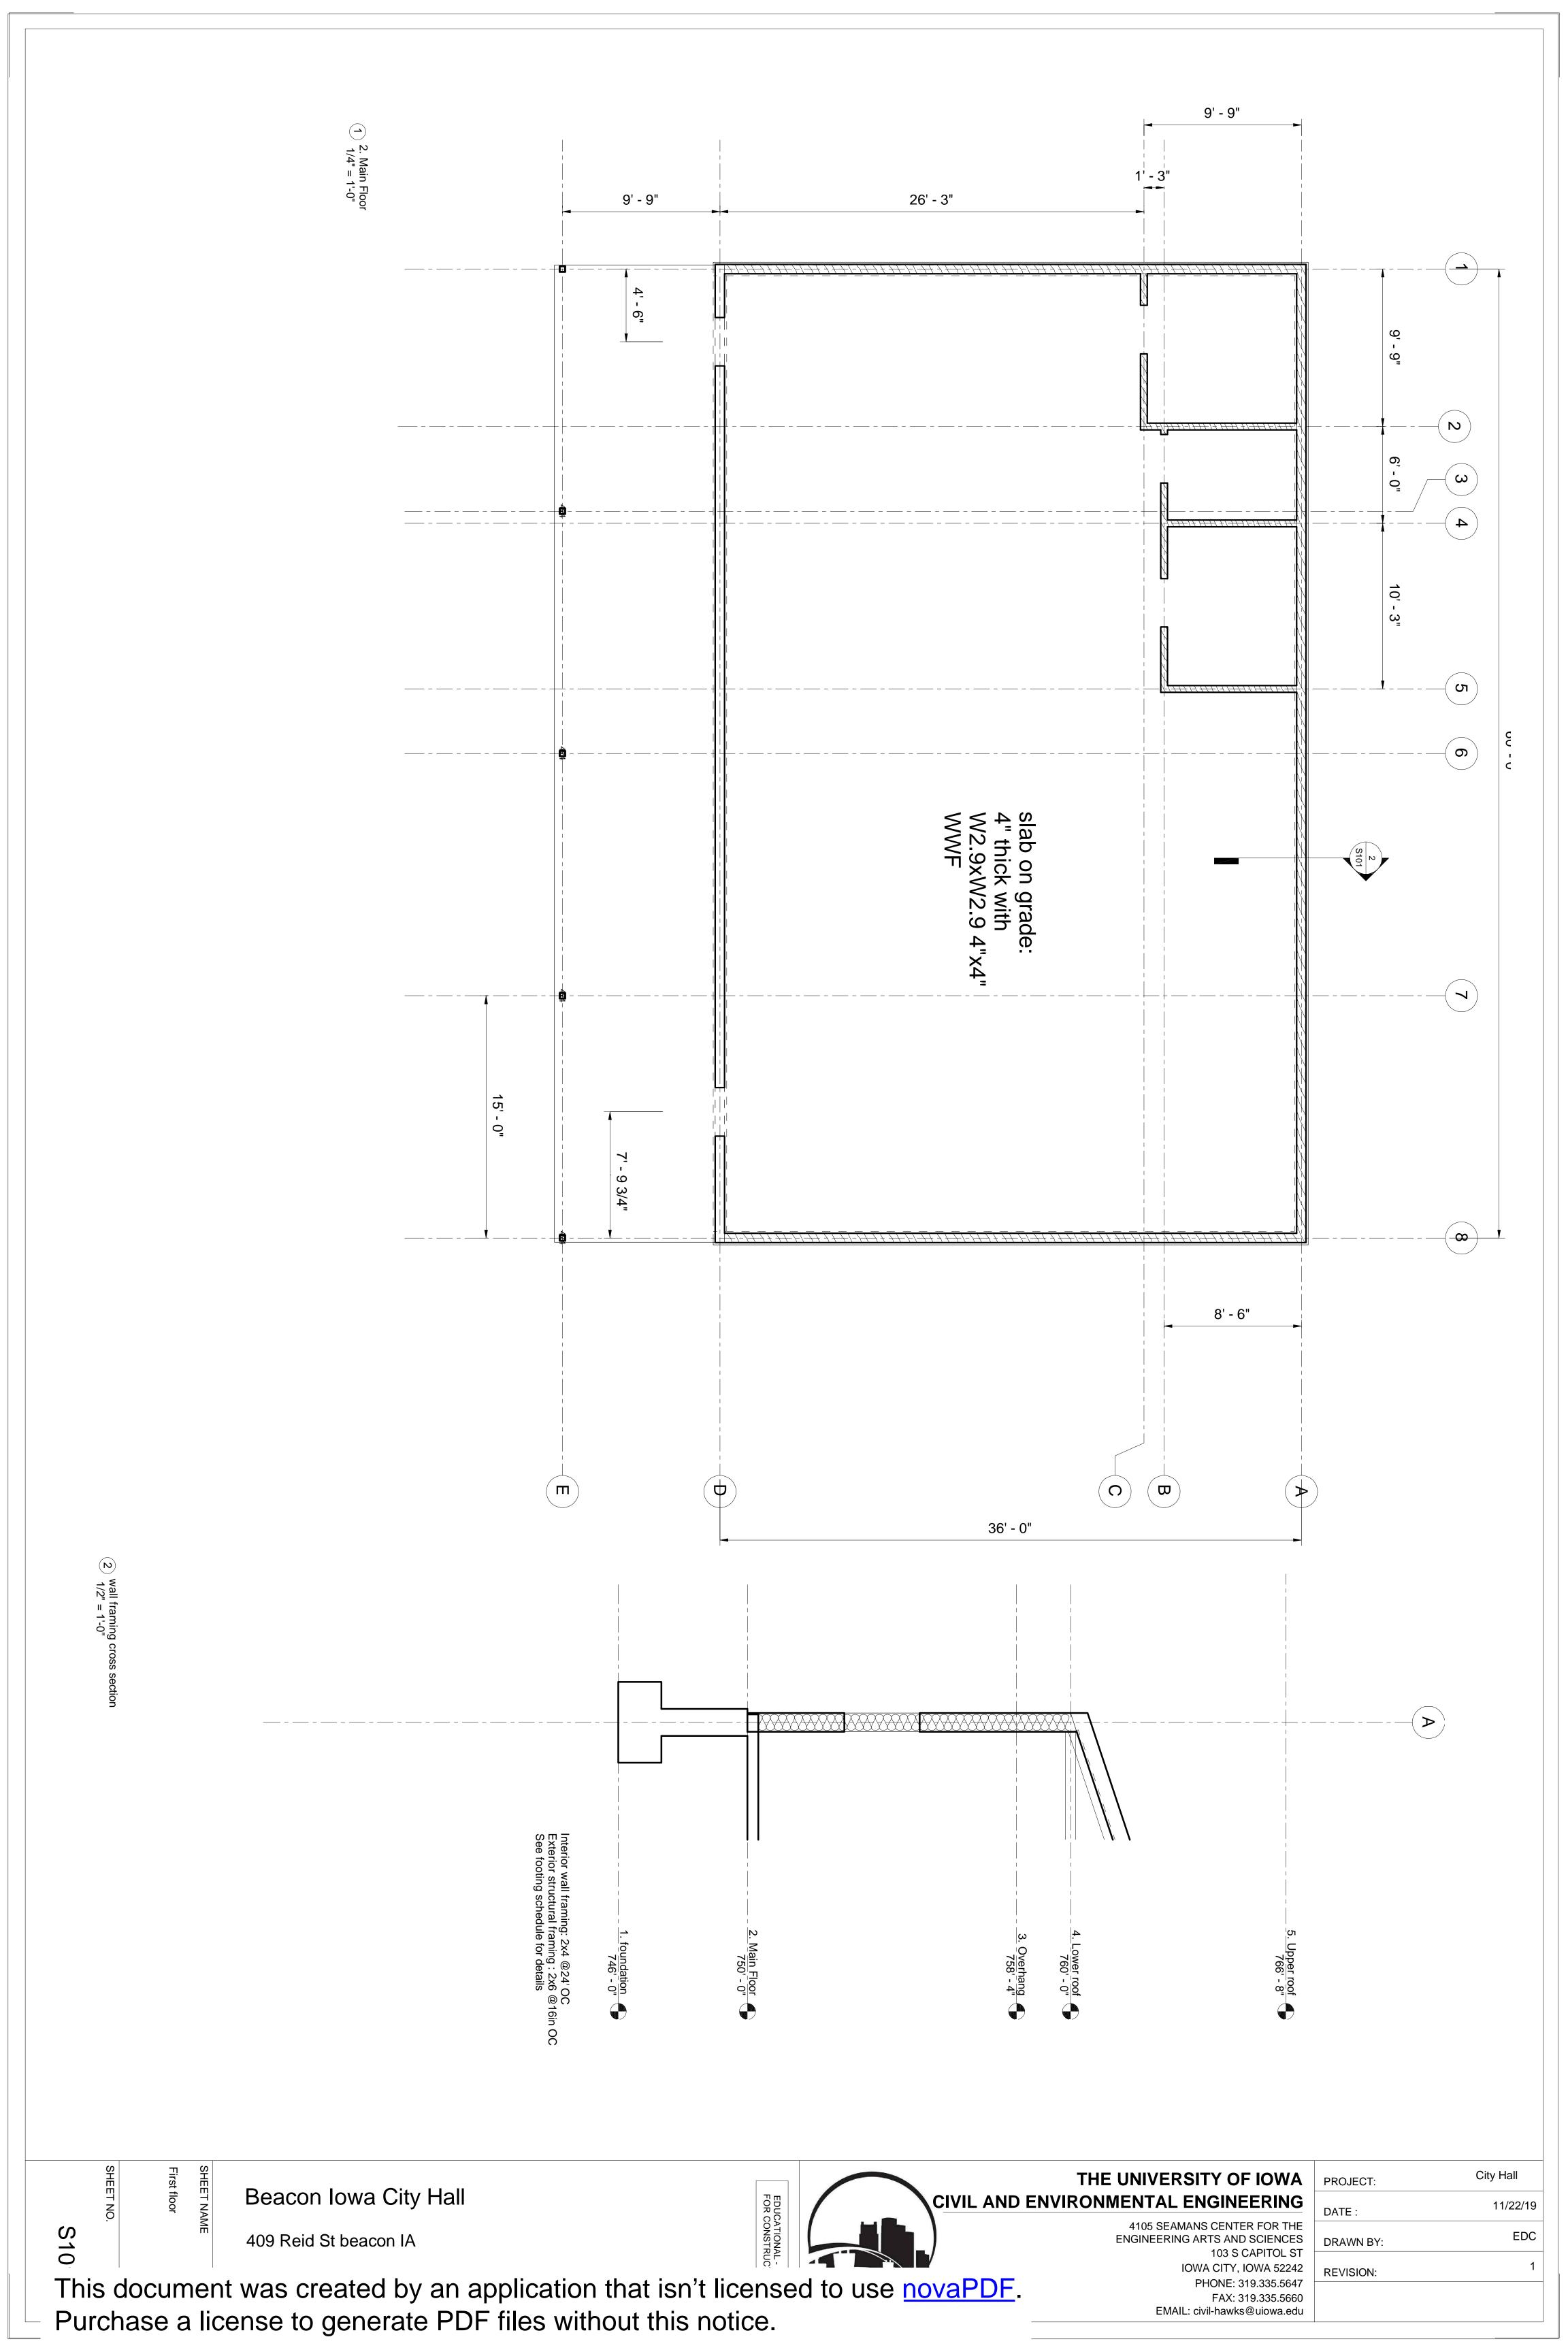
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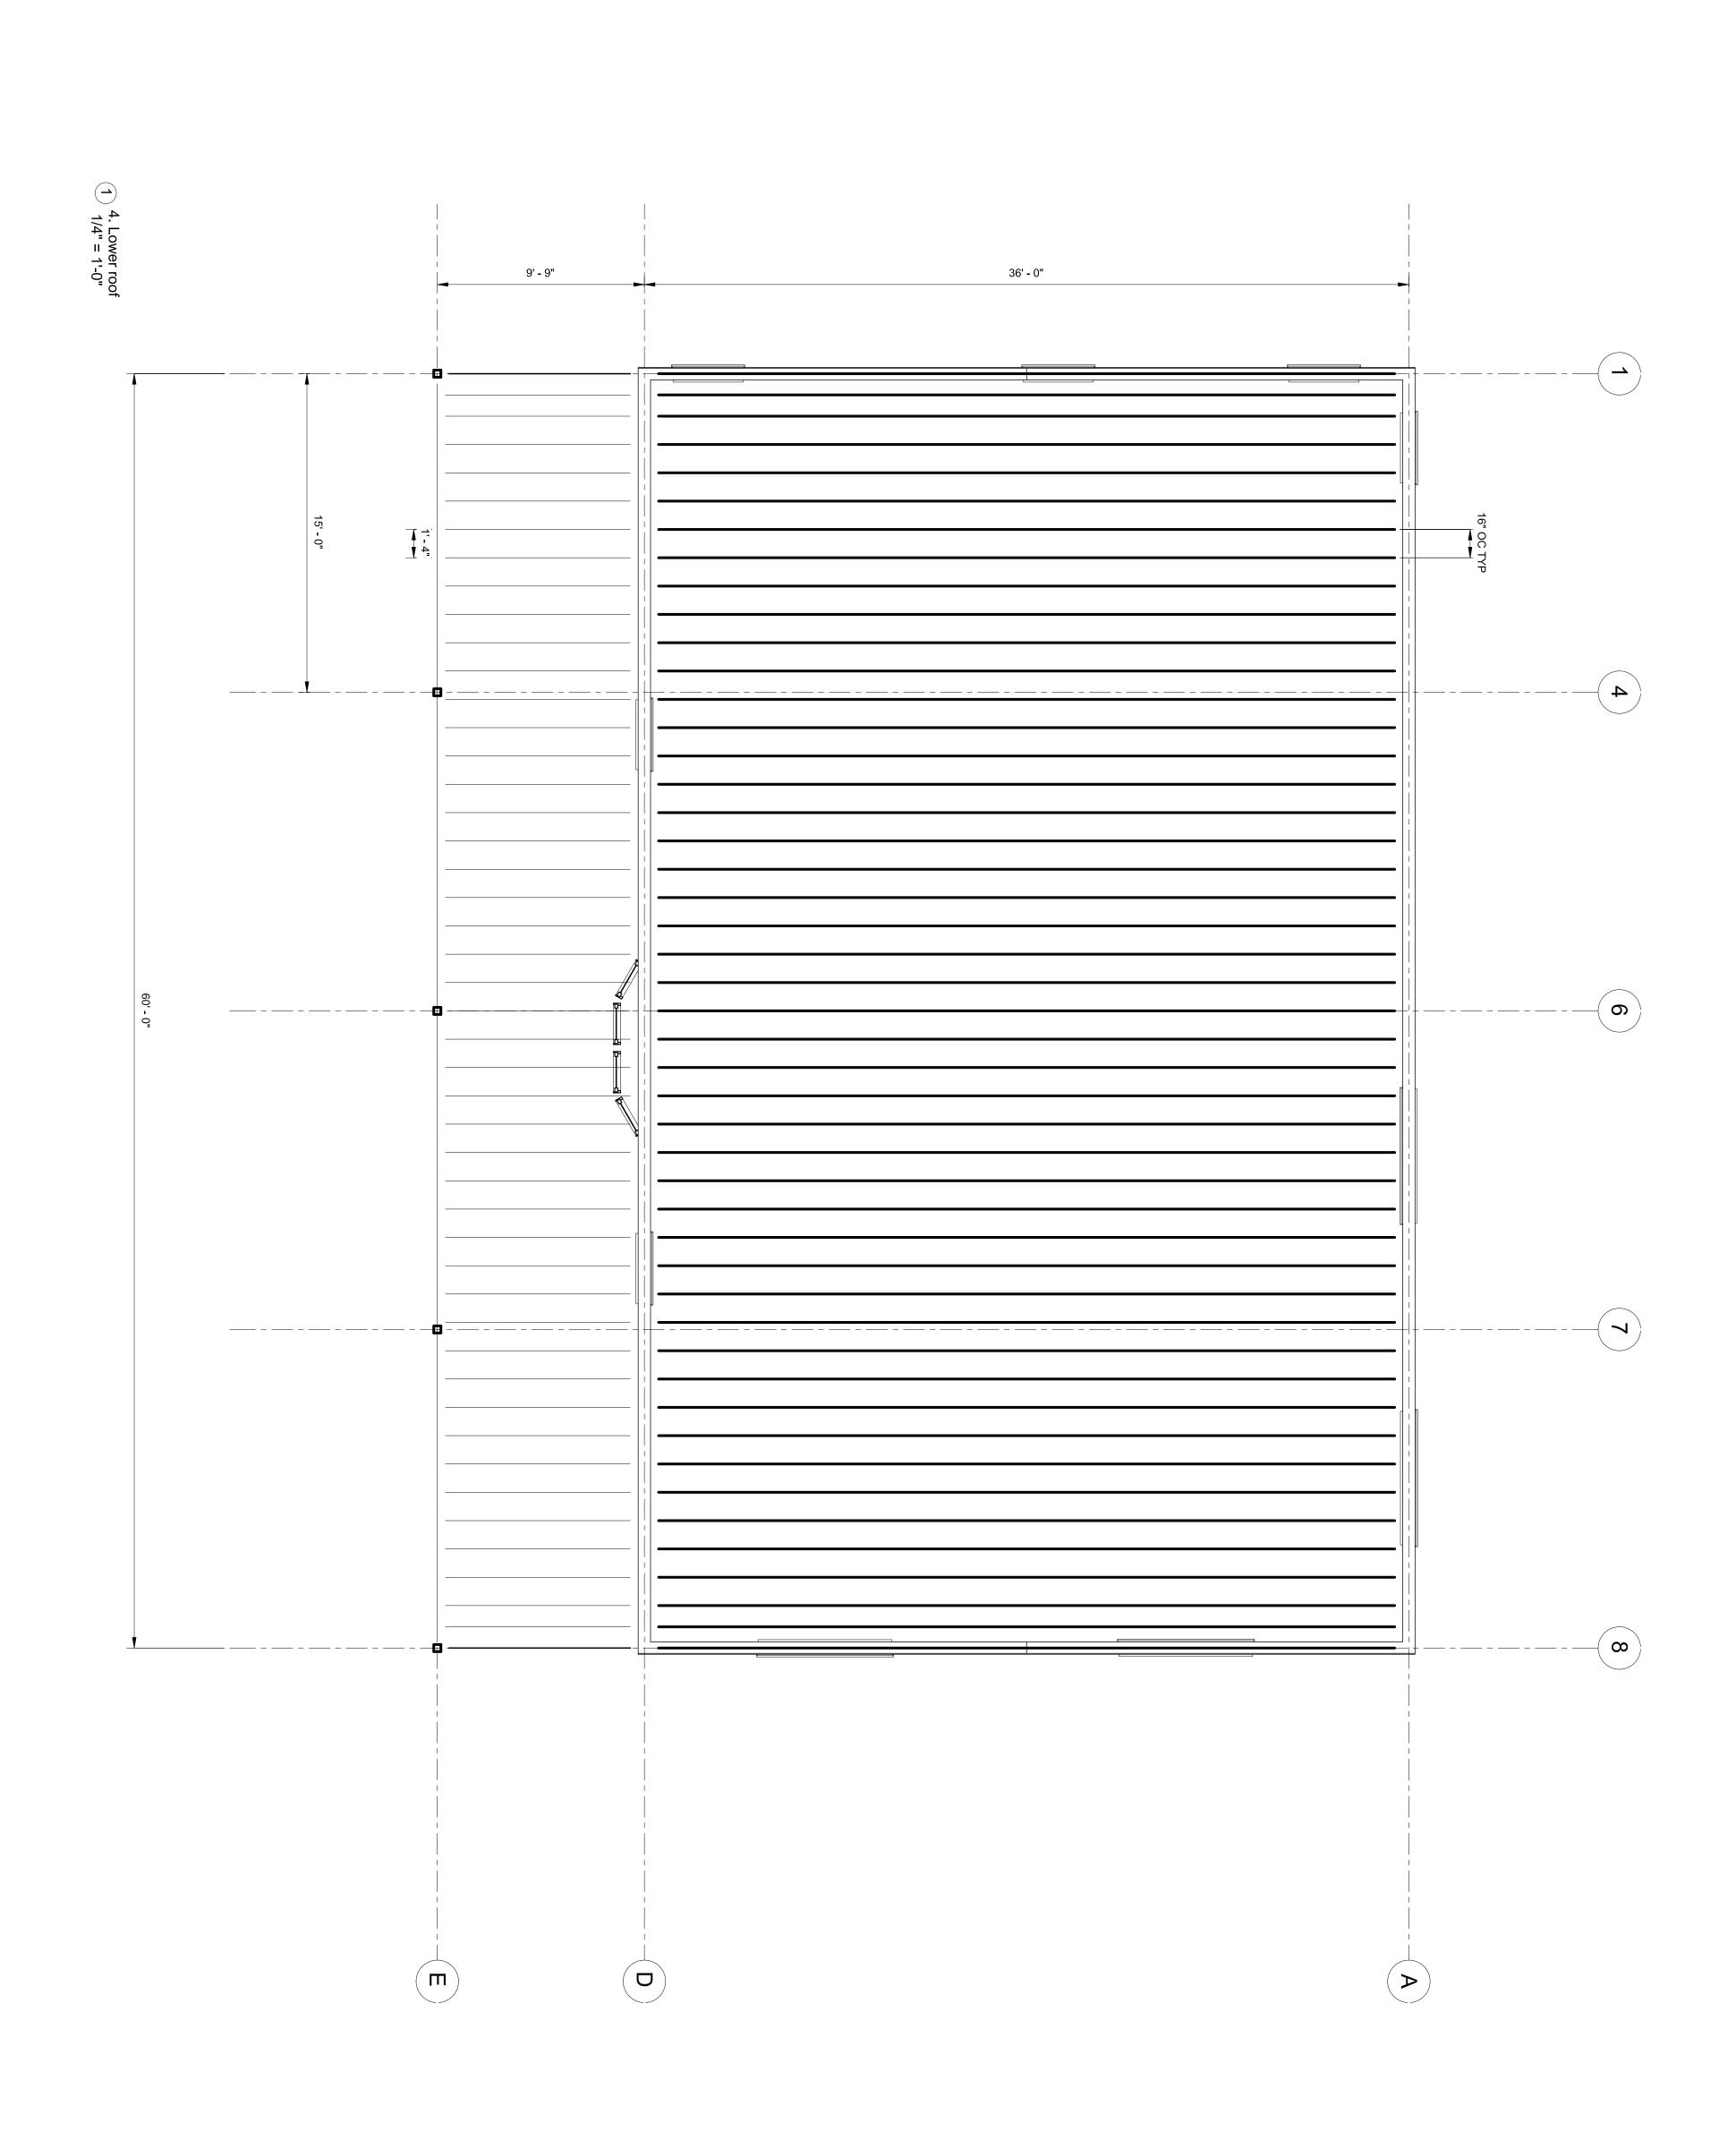
EROSION CONTROL DETAIL

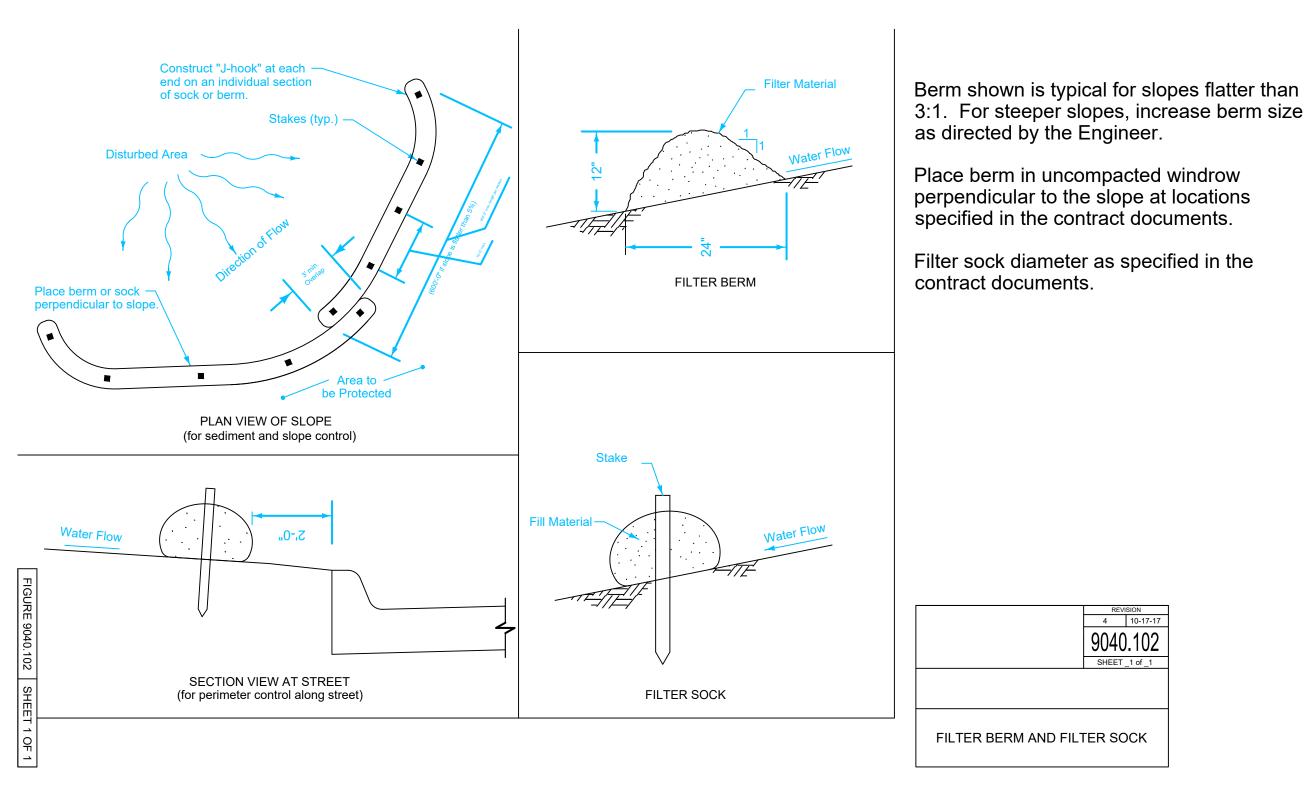SHEET NO.

DETAIL DRAWINGS NOT TO SCALE



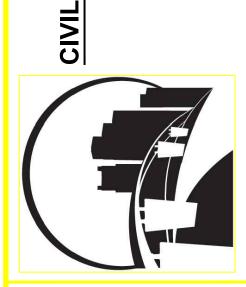



Roof Framing

Beacon Iowa City Hall


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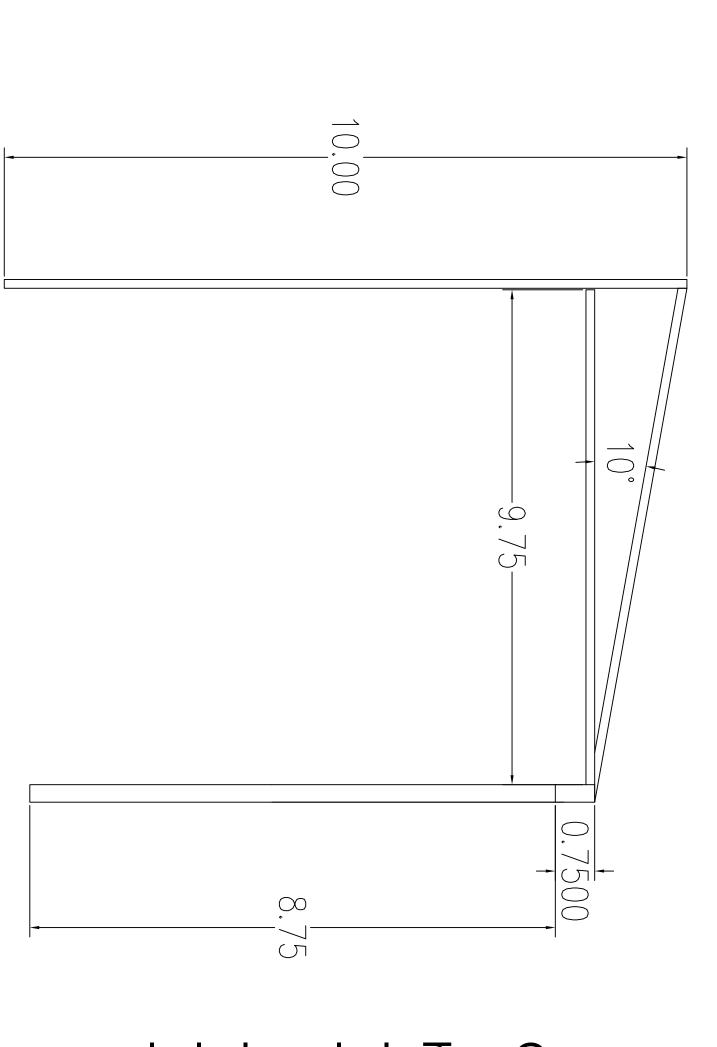
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103 S CAPITOL ST
IOWA CITY, IOWA 52242
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FAX: 319.335.5660
EMAIL: civil-hawks@uiowa.edu

| PROJECT: | City Hall |
|-----------|-----------|
| DATE: | 11/22/19 |
| DRAWN BY: | EDC |
| REVISION: | 1 |
| | |



Roof Truss:

-Howe (K) -top cord: 2 -bottom -spacing: -web members: 2x4 sawn lumber cord: 2x6 4 panel 2x6 sawn lumber sawn lumber

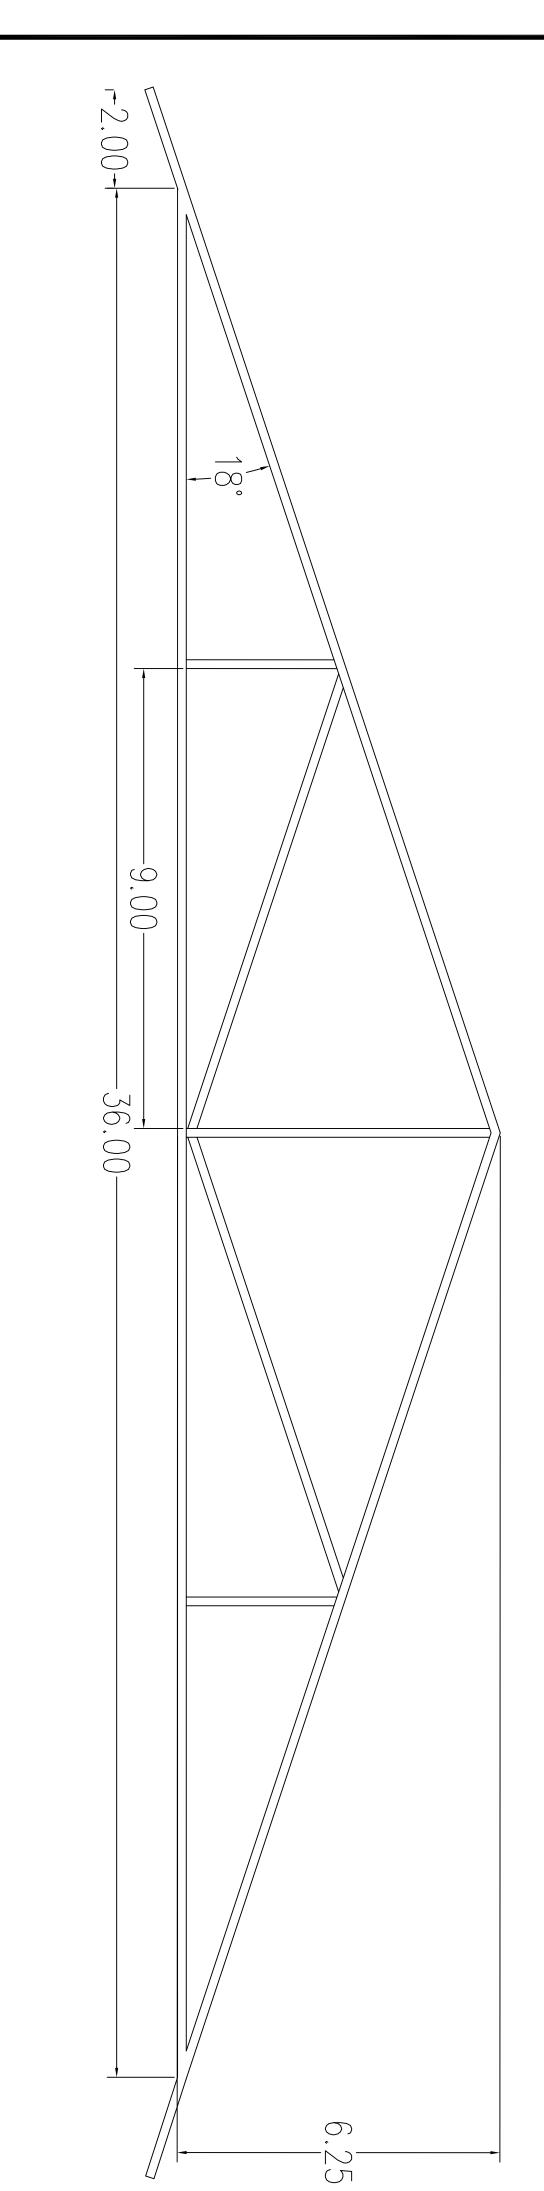

Overhang:

horizontal members: 2x4 sawn lumber -angled member: 2x4 sawn lumber at 10 degrees -member spacing: 16" OC

-overhang beam: 60'x5x5"x9" -column support: 4"x4" -column spacing: 15'

S103 ROOF FRAMING SHEET NAME 2

SHEET NAME

BEACON IOWA CITY HALL
PROJECT ADDRESS 1
409 REID ST BEACON IA



THE UNIVERSITY OF IOWA CIVIL AND ENVIRONMENTAL ENGINEERING

4105 SEAMANS CENTER FOR THE ENGINEERING ARTS AND SCIENCES 103 S CAPITOL ST IOWA CITY, IOWA 52242 PHONE: 319.335.5647 FAX: 319.335.5660 EMAIL: civil—hawks@uiowa.edu

CITY HALL PROJECT: DATE : 11/22/19 EDC DRAWN BY: REVISION:

409 REID ST BEACON IA